



5'-0" PER VARIANCE APPROVED IN 1969 THROUGH RESOLUTION NO 444

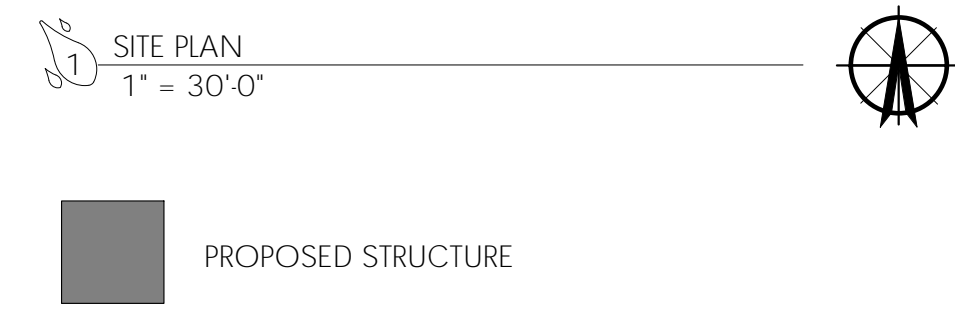


**GENERAL INFORMATION**

<b>PROJECT ADDRESS</b>	8700 SE 71ST STREET MERCER ISLAND, WA 98040
<b>CPD PROJECT NUMBER</b>	TBD
<b>ASSESSOR'S PARCEL #</b>	5451100575
<b>LEGAL DESCRIPTION</b>	MERCER ISLAND CTRY CLUB ESTS # 1 LESS POR W OF LN BEG ON N LN TH OF 345.66 FT E OF NW COR TH S 00:47.40 W 174 FT TO S LN OF SD TR A & TERM SD LN Plat Block: Plat Lot: A
<b>PROJECT DESCRIPTION</b>	REPLACE PREVIOUSLY EXISTING SEASONAL AIR SUPPORTED STRUCTURE TO COVER 4 EXISTING RE- SURFACED TENNIS COURTS
<b>ZONE</b>	R9.6
<b>PROJECT DIRECTORY</b>	
<b>OWNER</b>	MERCER ISLAND COUNTRY CLUB 8700 SE 71ST STREET MERCER ISLAND, WA 98040
<b>ARCHITECT</b>	CLINT BAILEY RAIN CITY ARCHITECTURE 206.636.1163 clint@raincityarchitecture.com
<b>GENERAL CONTRACTOR</b>	PENNON CONSTRUCTION 9750 3RD AVE NE SUITE 250 SEATTLE, WA 98115

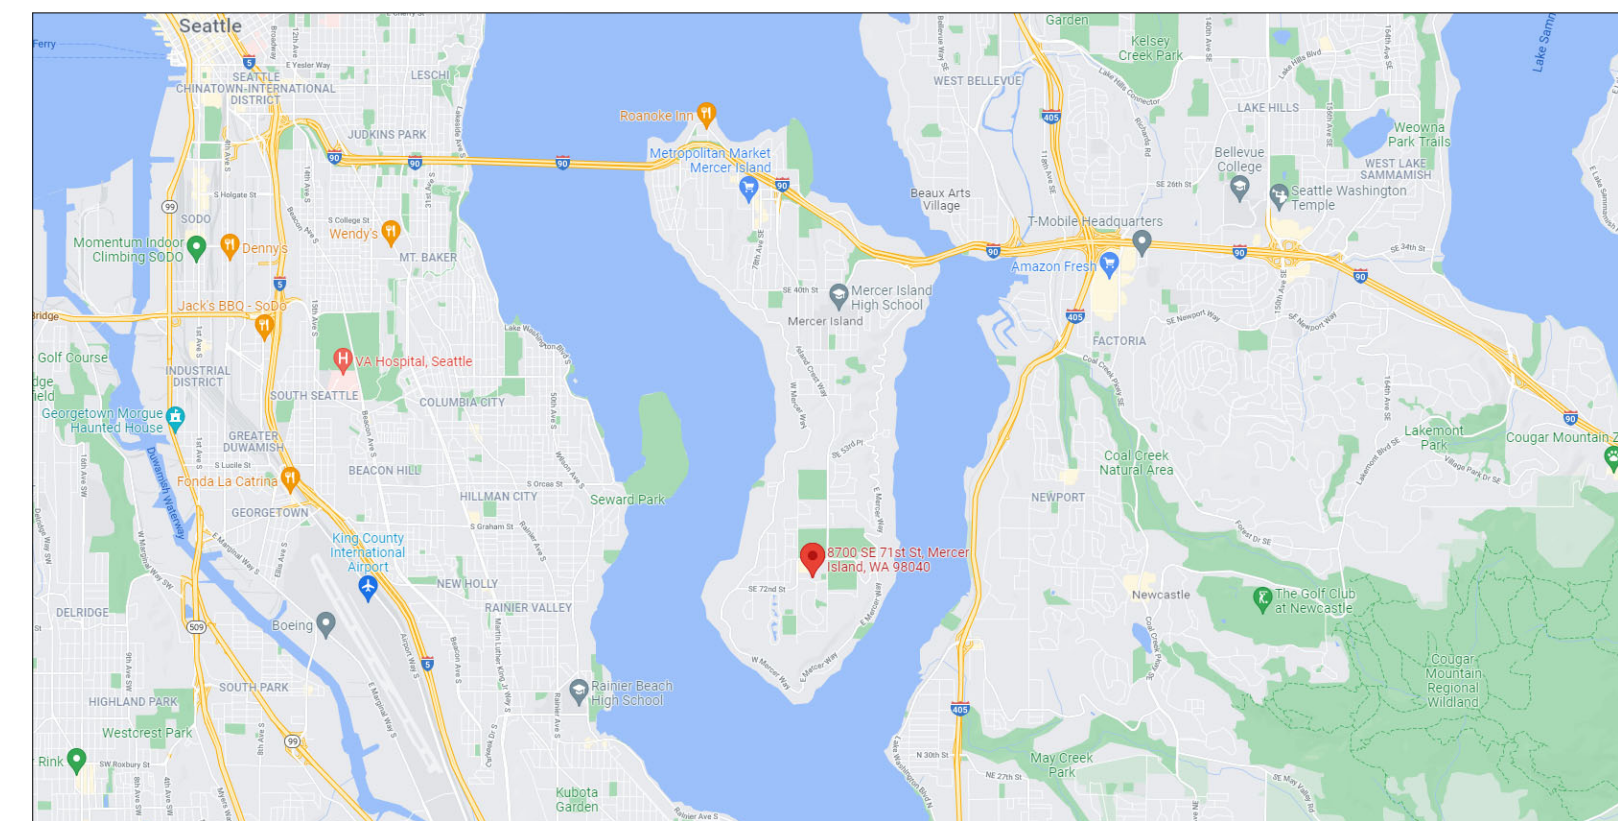

VICINITY PLAN

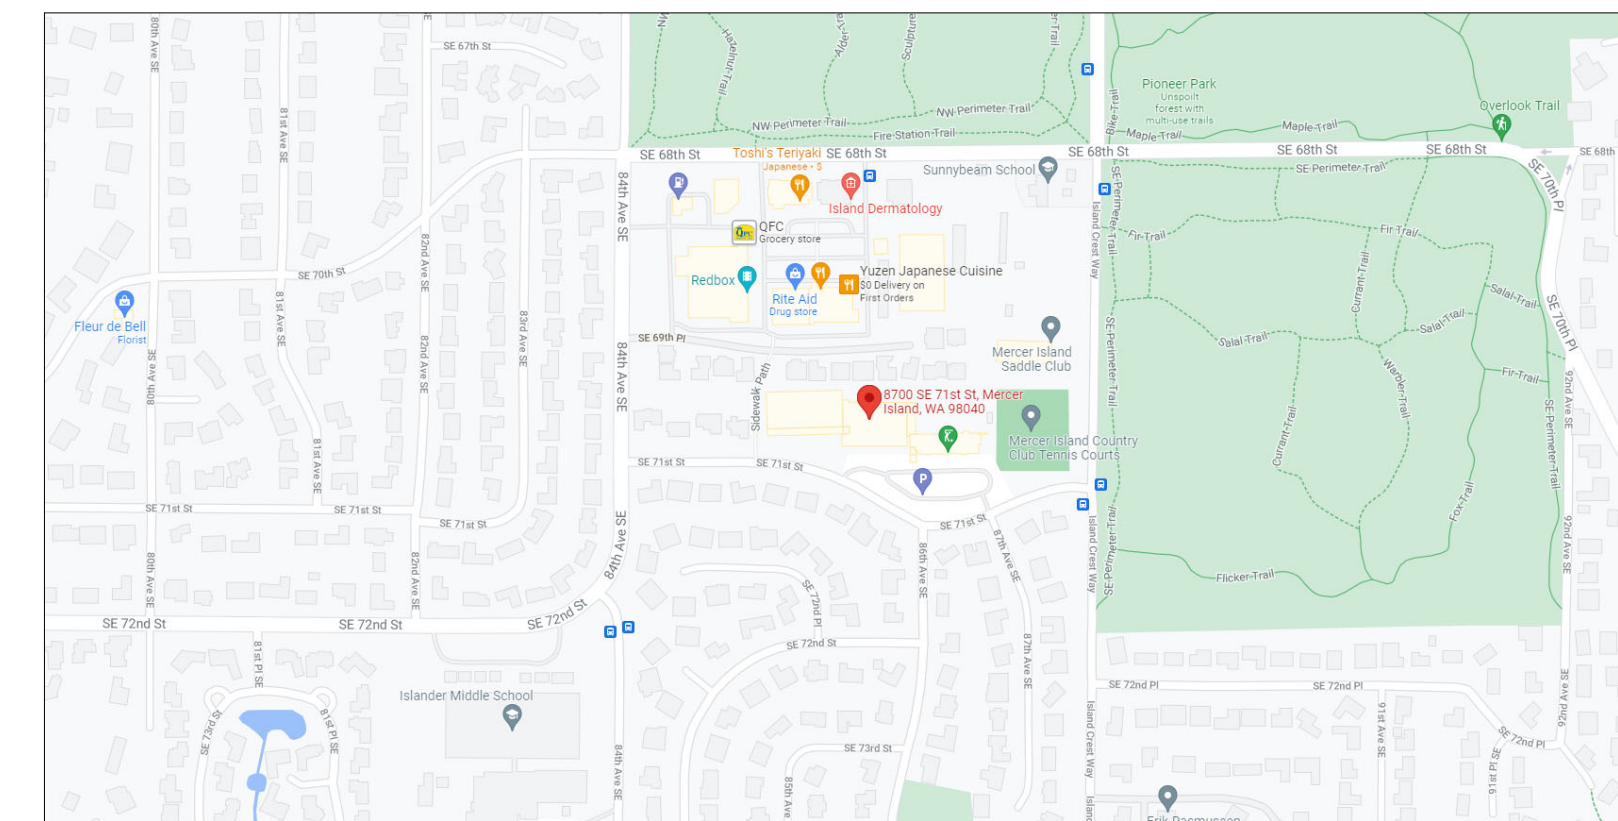

LOCATION PLAN

NOT FOR  
CONSTRUCTION  
FOR REFERENCE  
ONLY

**MICC- TENNIS COURT SHELTER**

8700 SE 71ST ST, MERCER ISLAND, WA 98040

COVERSHEET

REVISIONS

**A000**

SCHEMATIC DESIGN

2/7/2022  
5:18:00 PM

As Indicated



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Architecture, LLC, SEATTLE, WA



PROJECT RESPONSIBILITY MATRIX					
	Furnished by Arizon	Installed by Arizon	Furnished by Others	Installed by Others	Notes
<b>GENERAL</b>					
Site Survey			●		
Building Permits			●		
Soil Borings & Report			●		
Architectural Drawings			●		
Building Code and Zoning Reviews			●		
Air Structure Design Drawings	●				
Signed Sealed Structural Drawings (Air Structure)	●				
Signed Sealed Structural Drawings (Grade Beam)	●				
Signed Sealed Structural Drawings (Door Pads)	●				
Signed Sealed Structural Drawings (Inflation Equipment Pads)	●				
Signed Sealed Structural Drawings (All Other Items)			●		
Freight Scheduling	●				
Pallets, Crates, Skids, Packing Materials	●				
Freight Costs	●				
Unloading Goods at Job Site			●		
Site Security and Inventory of Delivered Goods			●		
<b>EXISTING 8" WIDE CONCRETE WALL</b>					
Excavation - Cutting Down to Flush with Court Surface			●	●	
<b>ANCHORAGE (EARTH ANCHORS)</b>					
Surface Modifications			●	●	
Earth Anchor Design / Selection of Earth Anchor			●	●	
Earth Anchor Material Including 3/4" Eyebolt on Top of Earth Anchor			●	●	
Earth Anchor Installation			●	●	
Anchor Locations	●			●	
Earth Anchor Tension Test at Each Anchor			●	●	
Final Anchor Check			●	●	
<b>ANCHORAGE (CLAMP CHANNEL FOR INTERIOR FLAP)</b>					
Steel Clamp Channel	●			●	
Steel Clamp Channel Fabrication Drawings	●			●	
Drop-in Anchors	●			●	
Anchor Bolts, Hex Nuts, Washers, and Set Screws	●			●	
Perimeter Gasket	●			●	
<b>DOORS</b>					
Concrete Door Pads			●	●	
3-Leaf Revolving Doors / Personnel Air Lock	●			●	
Emergency Exit Doors	●			●	
Clamp Channel for Fabric Attachment	●			●	1.
Door Anchors	●			●	
Control Cable Ring Shackles	●			●	
Lighted Exit Sign	●	●			1.
Exterior Door Light Fixtures	●			●	7.
Wiring within Door Frame and 3 ft Cord with L7-20P Plug	●	●			1.
All Wire Terminations for Door Lights			●	●	7.
Power Supply Stub-Up and Receptacles / Junction Boxes at Door Locations			●	●	
Keys & Locks	●				

PROJECT RESPONSIBILITY MATRIX					
	Furnished by Arizon	Installed by Arizon	Furnished by Others	Installed by Others	Notes
<b>AIR HANDLING UNIT - HVAC EQUIPMENT</b>					
Air Handling Unit (AHU)	●			●	
Concrete Equipment Pad			●	●	
Electrical Wiring Between Section Splits			●	●	3.
Electrical Conduit Stub-Ups			●	●	
Electrical Conduit to Air Handling Unit			●	●	
Electrical Service to Junction Box at Equipment Pad			●	●	3.
Electrical Service from Junction Box at Equipment Pad to Air Handling Unit			●	●	3.
Electrical Contractor to Energize Unit and Test Electrical Connections.			●	●	9.
Final Termination of Electrical Service at Air Handling Unit			●	●	3.
Gas Service to Job Site			●	●	
Gas Meter			●	●	
Gas Line from Meter to Equipment Pad			●	●	
Gas Line from Equipment Pad to Air Handling Unit			●	●	
Gas Regulator (Required at Connection to Air Handling Unit)			●	●	8.
Clamp Channel for Fabric Attachment	●	●			1.
Inflation Unit Commissioning	●				
Thermostat	●	●			1.
Remote Touch Screen Controller (If Applicable)	●			●	
Wind Sensor	●			●	6.
Wire from Remote Touch Screen to Local Area Network (Signal Booster if Applicable)			●	●	
Wire for Wind Sensor and Signal Booster (If Applicable)			●	●	
Snow Sensor	●	●			1.
<b>BACK-UP POWER GENERATION</b>					
Back-up Generator	●			●	
Gas Service to Job Site			●	●	
Gas Meter			●	●	
Gas Line from Meter to Equipment Pad			●	●	
Gas Line from Equipment Pad to Generator			●	●	
Gas Regulator (Required at Connection to Generator)			●	●	8.
Automatic Transfer Switch (ATS)	●	●			1.
Electrical Wiring from Utility Power to Automatic Transfer Switch			●	●	3.
Electrical Wiring from Generator to Automatic Transfer Switch			●	●	3.
Electrical Wiring from Automatic Transfer Switch to Air Handling Unit	●	●			1.
Generator Start-Up & Testing			●	●	2.
Automatic Transfer Switch Testing			●	●	2.
<b>DOME</b>					
Fabric	●			●	
Field Joint Bars and Gasket	●			●	
Catenary Cables	●			●	
Cable Shackles	●			●	
<b>LIGHTING</b>					
"D" Ring Support Discs	●			●	1.
Light Fixtures	●			●	
Twist-Lock Plug on Fixture	●	●			1.
Twist-Lock Connector Body on Wire (Fixture End)	●			●	
SE00W Cord from Fixtures to Junction Box at Grade Beam	●			●	4.
Termination of Wire at Junction Box at Grade Beam			●	●	4.
Electrical Service			●	●	4.
Switching / Lighting Controls			●	●	
Emergency Egress Lighting			●	●	
Power of Emergency Egress Lighting			●	●	

PROJECT RESPONSIBILITY MATRIX					
	Furnished by Arizon	Installed by Arizon	Furnished by Others	Installed by Others	Notes
<b>INSTALLATION</b>					
Forklift or Crane to hoist Air Handling Unit to the Mechanical Pad from the Road			●	●	
Fork Truck to Unload and Install Fabric, Doors, etc.			●	●	
Hand and Power Tools for Installation of Dome			●	●	
Installation Labor			●	●	
Installation Supervision (8 days)	●				
Polyethylene Sheeting			●	●	
Installation of Interior components - Lighting, Netting, etc.			●	●	
Aerial Lift for Installation of Interior Components			●	●	
Electrical Work			●	●	
Mechanical Work / Gas plumbing			●	●	
<b>COMMISSIONING</b>					
Customer Training	●				
Owner's Manual	●				
<b>NETTING AND CURTAINS</b>					
Fabric Curtain with Viewing Mesh Panel	●			●	
Wedge Netting	●			●	
Grommet Strip in Dome for Wedge Netting			●	●	1.
Fabric Curtain Cable Supports	●			●	
Fabric Curtain Tension Plate Assemblies	●			●	
<b>MISCELLANEOUS</b>					
Fabric Repair Kit	●				
<b>NOTES:</b>					
<ol style="list-style-type: none"> <li>Component is Factory Installed by the Manufacturer. Adjustments May be Required During Installation. All On-site Installation and or Adjustments are the Responsibility of Others and in Most Cases Require Qualified Professionals.</li> <li>To be Performed by the Local Generac Dealer or a Qualified Electrician with Generac Phone Support.</li> <li>See AM1.01 and AM2.01 for Details. All Field Wiring to be Performed by a Qualified Electrician.</li> <li>See AE1.01 and AE2.01 for Details. All Field Wiring to be Performed by a Qualified Electrician.</li> <li>See AM1.01 for Pressure and Volume Requirements.</li> <li>Arizon will Provide 10 Feet of EMT Conduit and Wires for Temporary Mounting of the Wind Sensor for Initial Commissioning of the Air Handling Unit Controls. The Owner's Electrician Should Relocate the Sensor to an Appropriate Final Location Based on Prevailing Wind Conditions at the Jobsite. Installation Must be in Strict Accordance with the OEM's Installation Instructions.</li> <li>See AD1.01 and AD1.02 for details. All Field Wiring to be Performed by a Qualified Electrician.</li> <li>See AM1.01 for Natural Gas Volume and Pressure Requirements.</li> <li>Upon Energizing the Unit, Electrical Contractor will Check Circulation Fan for Proper Rotation. Backwards Rotation of Circulation Fan Indicates Incorrect Polarity of the Incoming 3-Phase Service Connection.</li> <li>Special Inspections as stated on sheet AS0.02 is the responsibility of the Owner/Contractor.</li> </ol>					

# ARIZON™

## BUILDING SYSTEMS

11880 Dorsett Rd.  
St. Louis, MO, USA 63043  
Tel: (314) 739-0037  
www.arizonbuildingsystems.com

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Dan Nordale  
8700 SE 71st Street  
Mercer Island, WA 98040  
Tel: (206) 295-3687

**JOB SITE ADDRESS:**  
8700 SE 71st Street  
Mercer Island, WA 98040

**ENGINEER:**

MISSOURI

# CASE

Engineering Inc.

796 Menz Court  
St. Louis, MO 63026  
T 314.349.1600  
F 314.349.1730  
CERTIFICATE OF AUTHORITY NO. 4002

⚠	UPDATED FROM SITE SURVEY AND NETTING REVISIONS	C JORDAN 02-18-2022
⚠	ISSUED FOR SUBMITTAL	C JORDAN 02-04-2022

**SUBMITTALS / REVISIONS**

**PROJECT NO:**  
A10396

**PROJECT:**  
MERCER ISLAND COUNTRY CLUB  
4 COURT TENNIS DOME

**SCALE:**  
AS NOTED

**DRAWING TITLE:**  
RESPONSIBILITY MATRIX

**SHEET:**  
AA1.00

NOT FOR CONSTRUCTION



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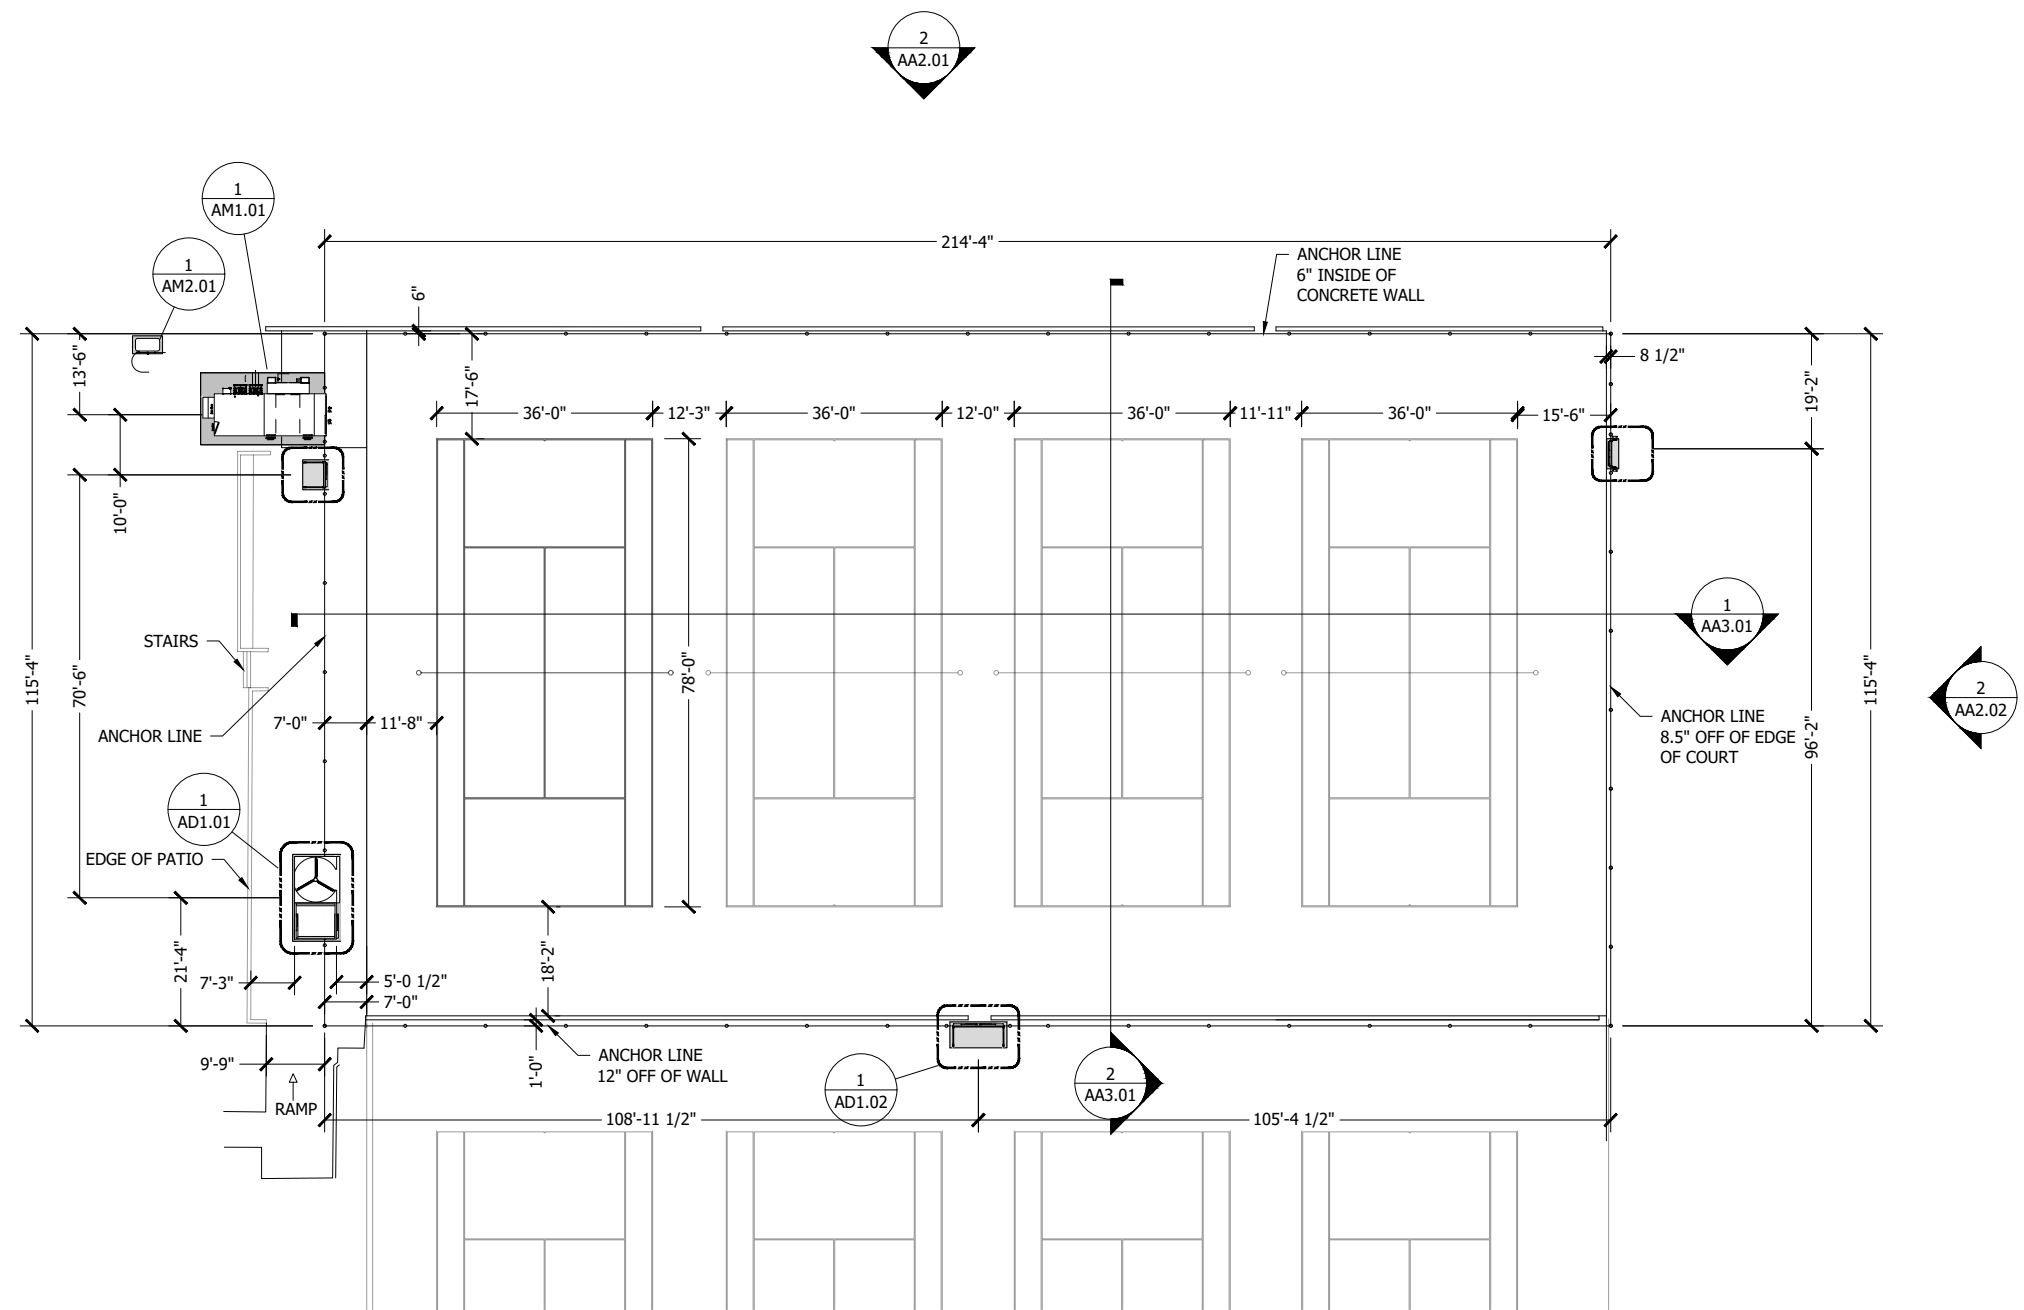
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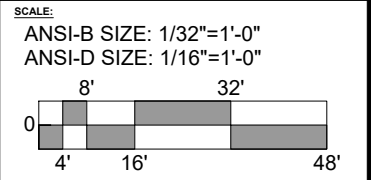


NO.	DESCRIPTION	DATE
1	UPDATED FROM SITE SURVEY AND NETTING REVISIONS	C JORDAN 02-18-2022
2	ISSUED FOR SUBMITTAL	C JORDAN 02-04-2022

**SUBMITTALS / REVISIONS**

**PROJECT NO:**  
 A10396

**PROJECT:**  
 MERCER ISLAND COUNTRY CLUB  
 4 COURT TENNIS DOME



**DRAWING TITLE:**  
 FLOOR PLAN

**SHEET:**  
 AA1.01

1 **DOME FLOOR PLAN**  
 SCALE: 1/16" = 1'-0"

**GENERAL NOTES:**  
 1. ALL DIMENSIONS ARE TAKEN TO ANCHOR LINE UNLESS NOTED OTHERWISE.  
 2. CODE STUDY AND COMPLIANCE WITH LIFE SAFETY ISSUES (INCLUDING BUT NOT LIMITED TO USE OF BUILDING, OCCUPANT LOAD, TRAVEL DISTANCE, INGRESS, EGRESS, FIRE RATING/SMOKE CONTROL REQUIREMENTS, ETC.) ARE THE RESPONSIBILITY OF THE OWNER.

**LEGEND**

CONCRETE

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(NORTH)

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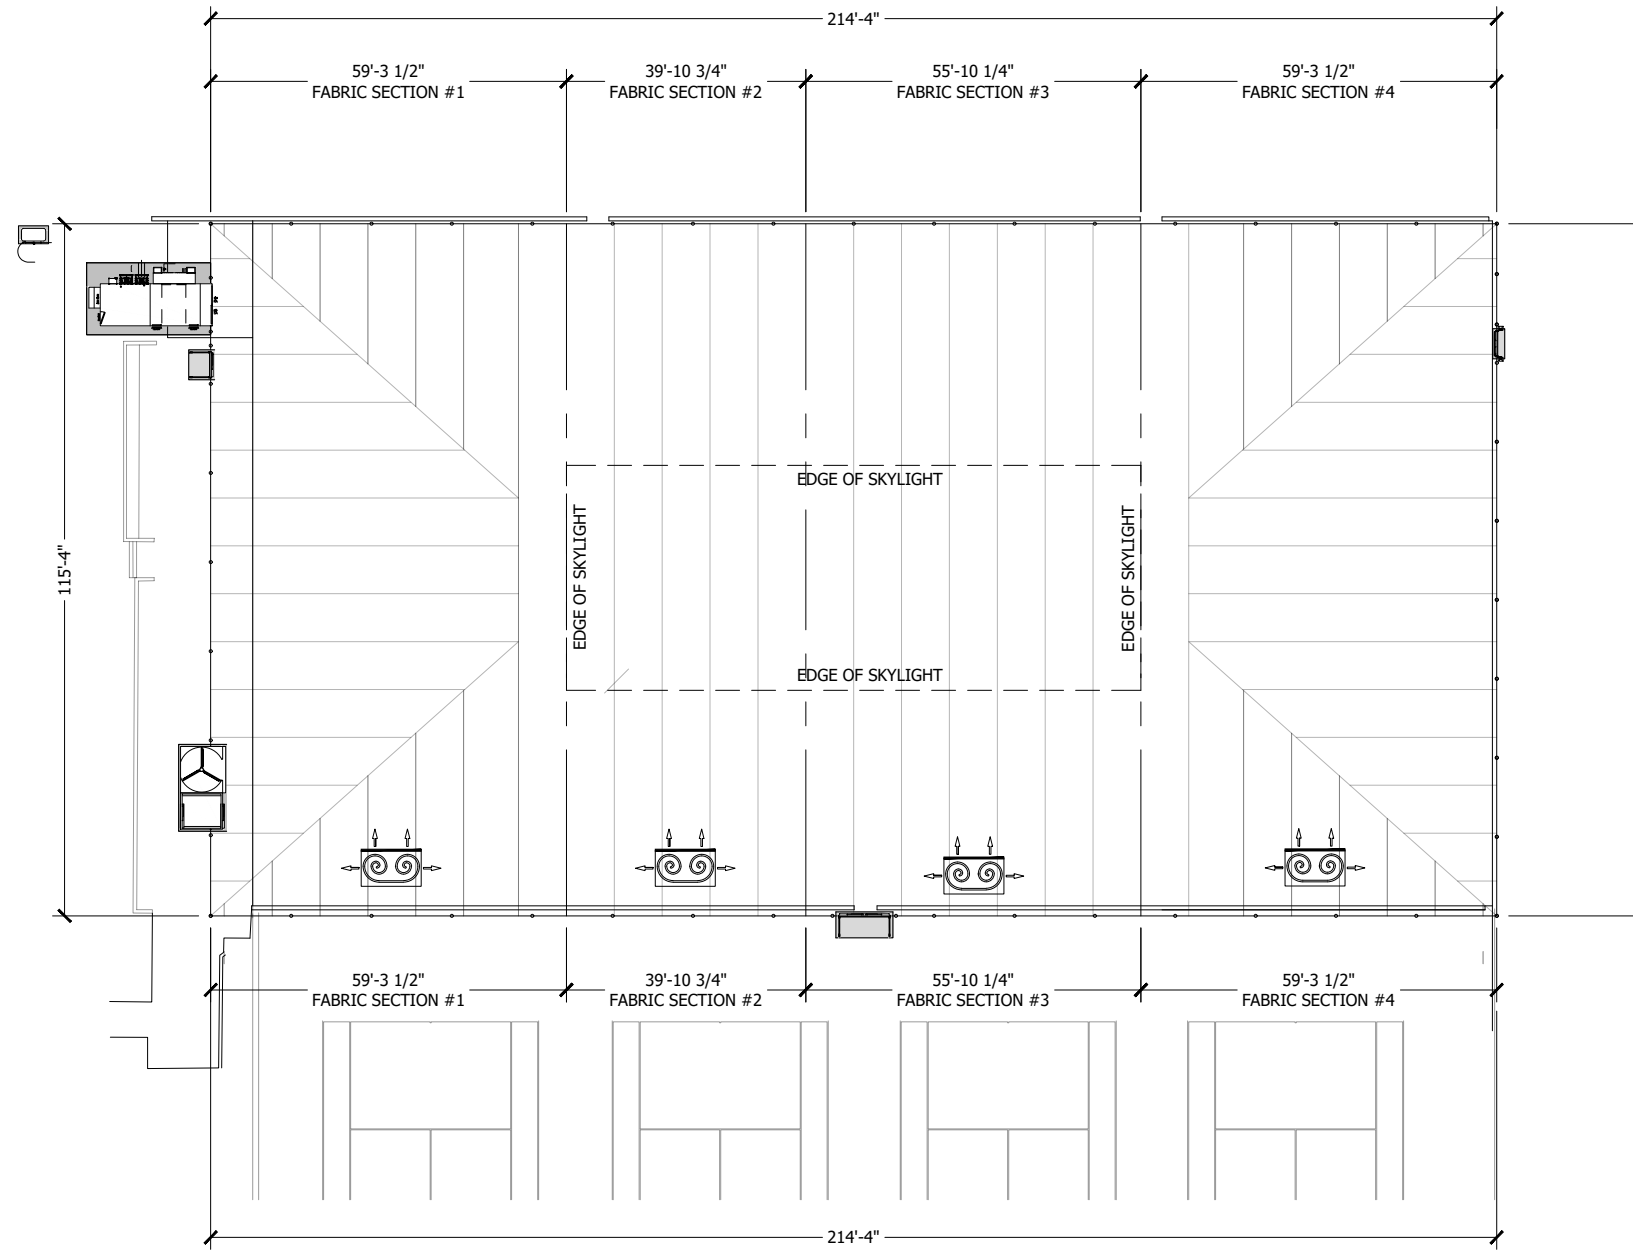
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 CERTIFICATE OF AUTHORITY NO. 4002



**LEGEND**

- EDGE OF SKYLIGHT
- FIELD JOINT (TYP.)  
AKA "SECTIONALIZING"  
(SEE 02/AS1.00)
- FABRIC SECTION PALLET
- CONCRETE

**GENERAL NOTES:**  
 1. ALL DIMENSIONS ARE TAKEN TO ANCHOR LINE UNLESS NOTED OTHERWISE.  
 2. LOCATIONS OF FIELD JOINTS ARE APPROXIMATE AND MAY VARY WITH MANUFACTURING.

	UPDATED FROM SITE SURVEY AND NETTING REVISIONS	C JORDAN 02-18-2022
	ISSUED FOR SUBMITTAL	C JORDAN 02-04-2022

**SUBMITTALS / REVISIONS**

**PROJECT NO:**  
 A10396

**PROJECT:**  
 MERCER ISLAND COUNTRY CLUB  
 4 COURT TENNIS DOME

**SCALE:**  
 ANSI-B SIZE: 1/32"=1'-0"  
 ANSI-D SIZE: 1/16"=1'-0"

**DRAWING TITLE:**  
 FABRIC SECTION PLAN

**SHEET:**  
 AA1.02

**1** **FABRIC SECTION PLAN**  
 SCALE: 1/16" = 1'-0"


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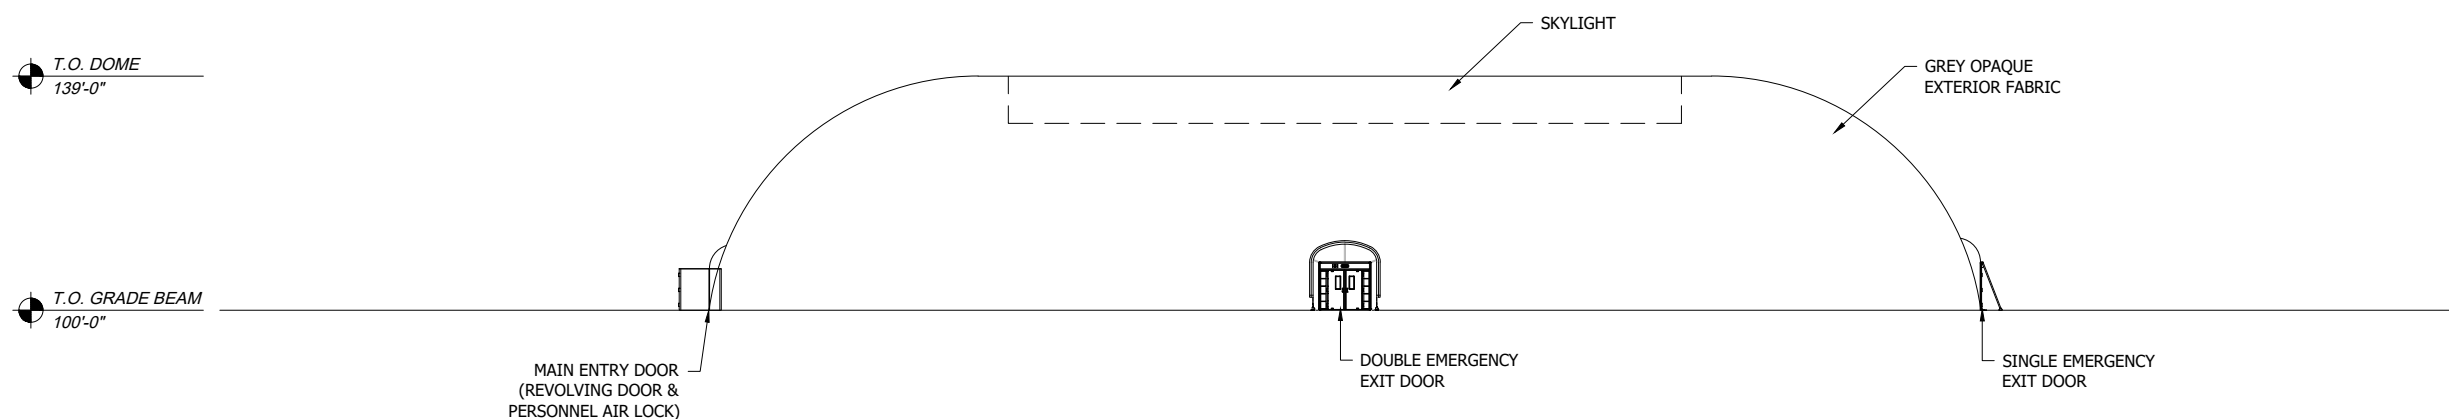
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**2 NORTH ELEVATION**  
 SCALE: 1/16" = 1'-0"




**1 SOUTH ELEVATION**  
 SCALE: 1/16" = 1'-0"

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**SUBMITTALS / REVISIONS**

**PROJECT NO:**  
 A10396  
**PROJECT:**  
 MERCER ISLAND COUNTRY CLUB  
 4 COURT TENNIS DOME

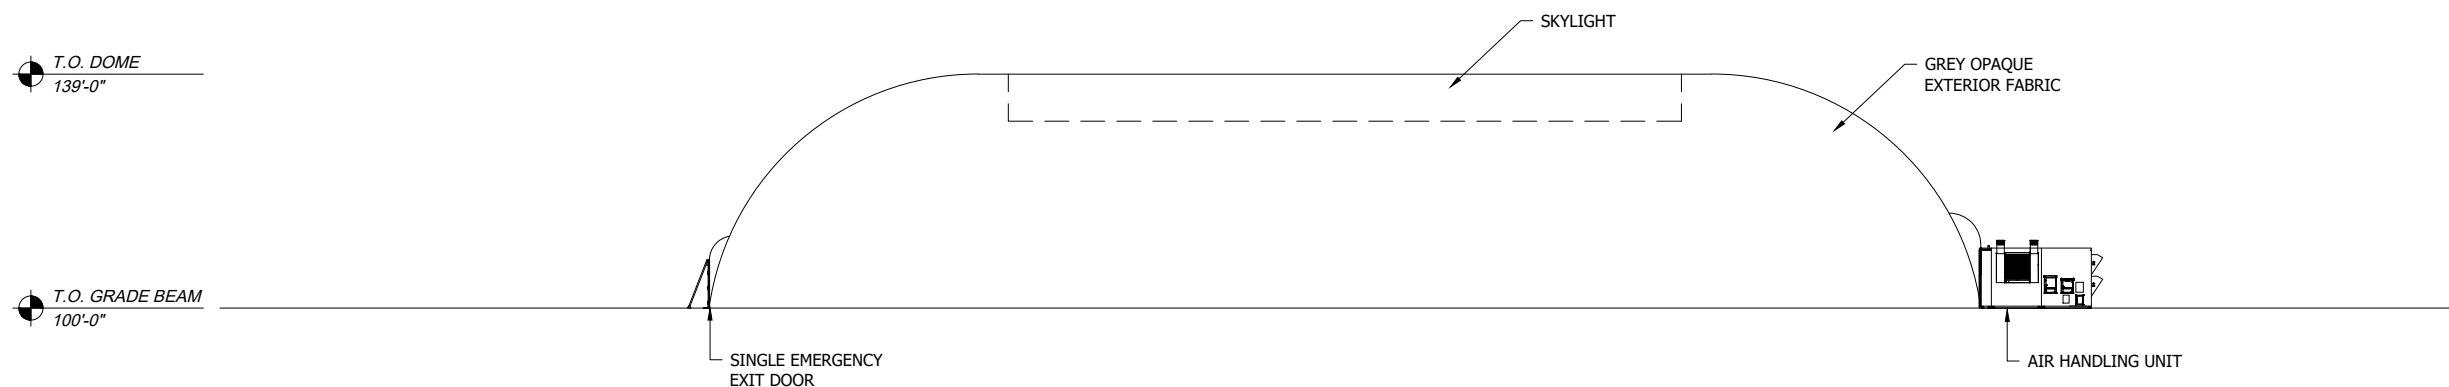**SCALE:**  
 ANSI-B SIZE: 1/32"=1'-0"  
 ANSI-D SIZE: 1/16"=1'-0"

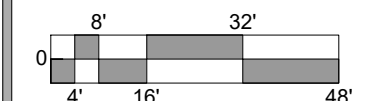

**DRAWING TITLE:**  
 EXTERIOR DOME ELEVATIONS

**SHEET:**  
**AA2.01**


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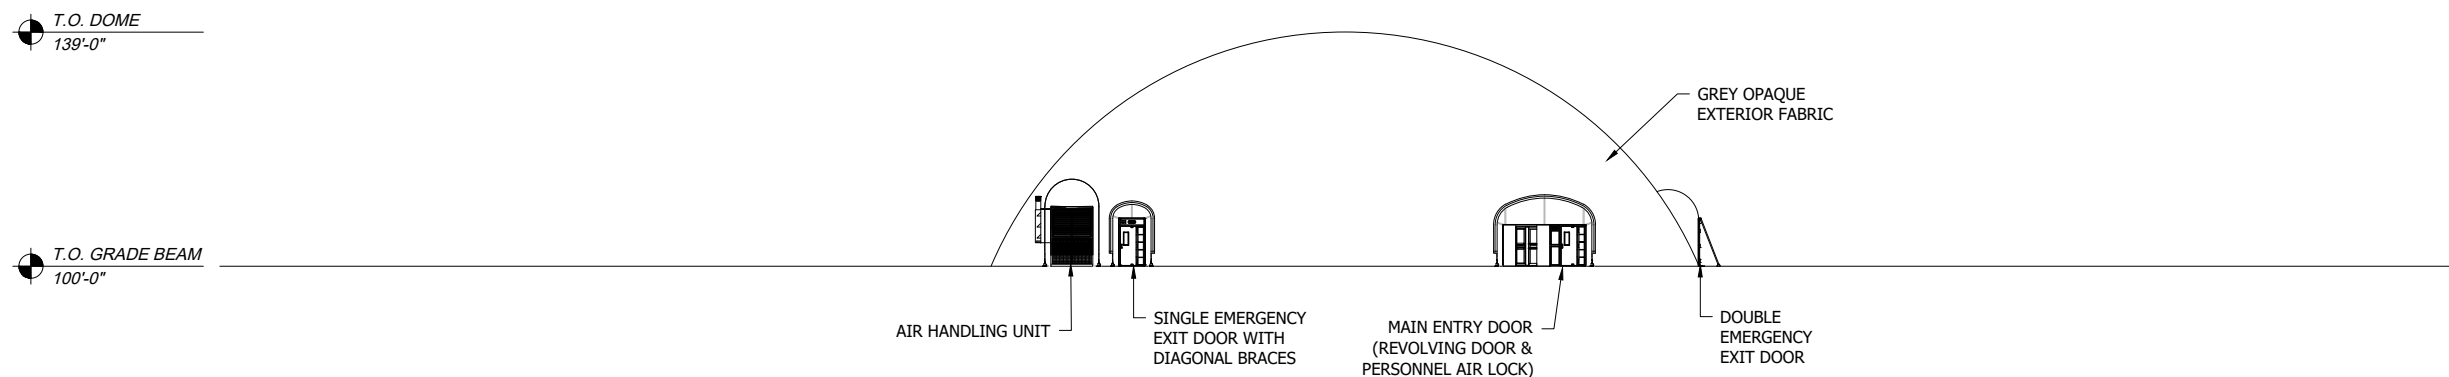
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**2 EAST ELEVATION**  
 SCALE: 1/16" = 1'-0"



**1 WEST ELEVATION**  
 SCALE: 1/16" = 1'-0"

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**SUBMITTALS / REVISIONS**

**PROJECT NO:**  
 A10396  
**PROJECT:**  
 MERCER ISLAND COUNTRY CLUB  
 4 COURT TENNIS DOME

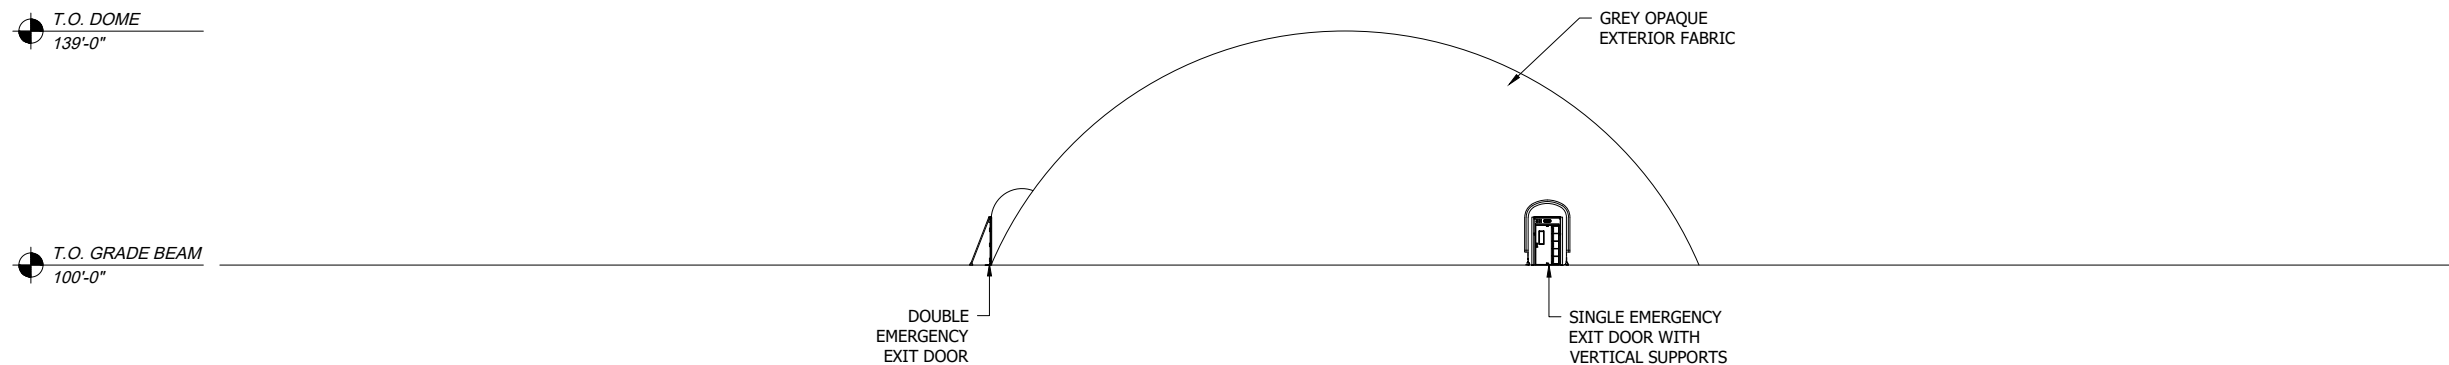**SCALE:**  
 ANSI-B SIZE: 1/32"=1'-0"  
 ANSI-D SIZE: 1/16"=1'-0"

**DRAWING TITLE:**  
 EXTERIOR DOME ELEVATIONS

**SHEET:**  
**AA2.02**

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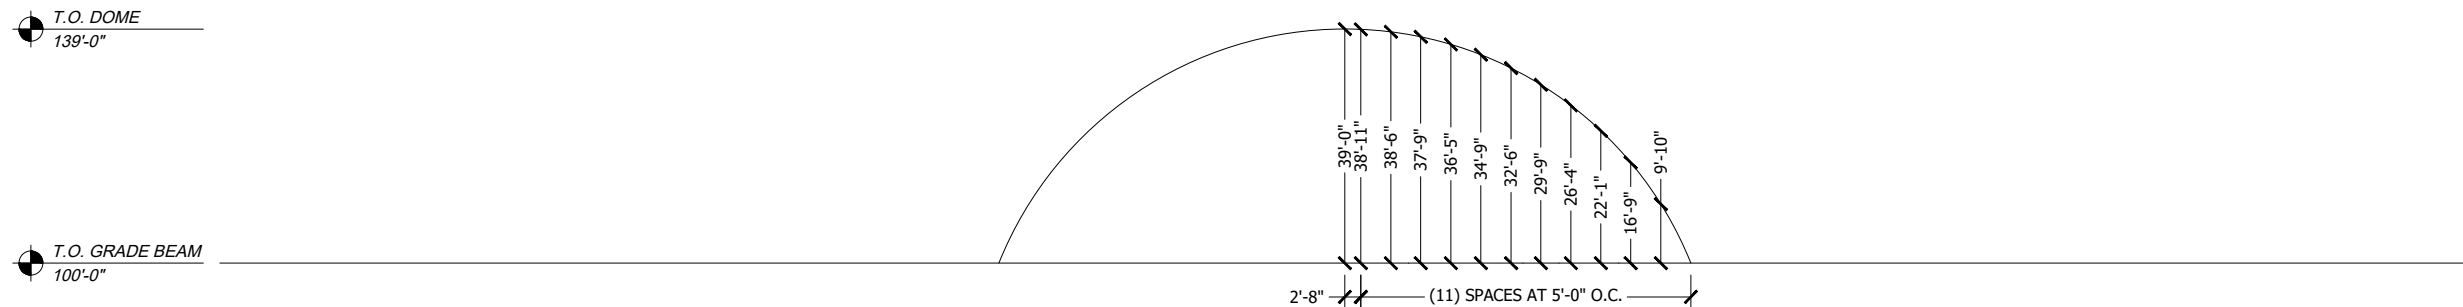
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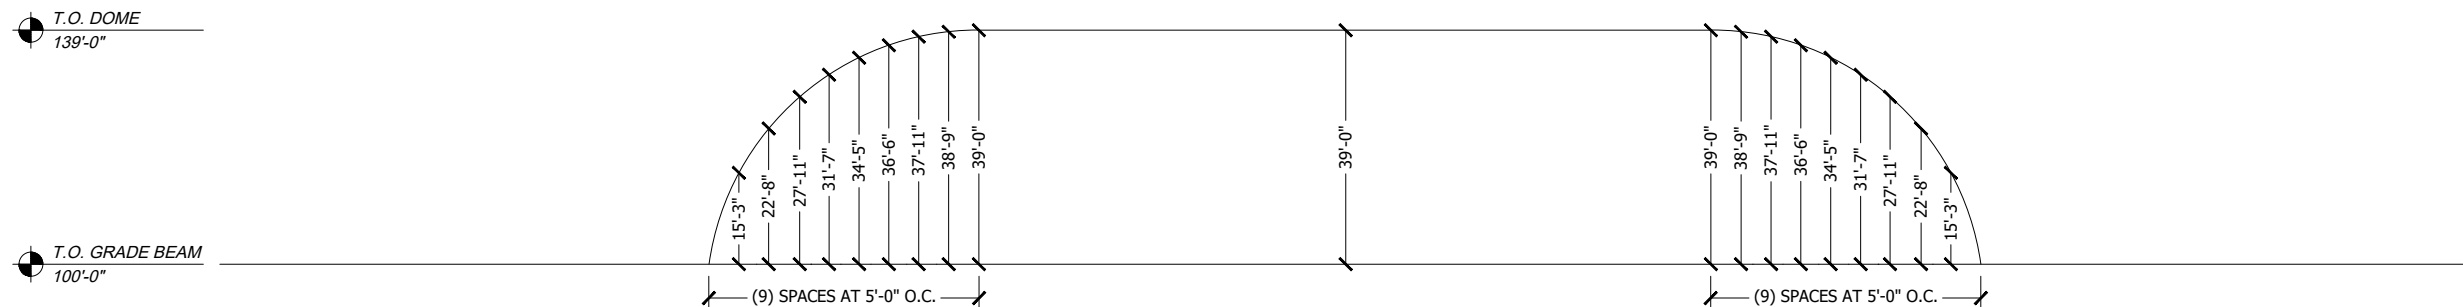
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**ENGINEER:**

MISSOURI  
**CASE**  
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 T 636.349.1600  
 F 636.349.1730  
 CERTIFICATE OF AUTHORITY NO. 4002



2 (APPROX.) DOME PROFILE - TRANSVERSE  
 SCALE: 1/16" = 1'-0"



1 (APPROX.) DOME PROFILE - LONGITUDINAL  
 SCALE: 1/16" = 1'-0"

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**SUBMITTALS / REVISIONS**


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 A10396  
**PROJECT:**  
 MERCER ISLAND COUNTRY CLUB  
 4 COURT TENNIS DOME

**SCALE:**  
 ANSI-B SIZE: 1/32"=1'-0"  
 ANSI-D SIZE: 1/16"=1'-0"


**DRAWING TITLE:**  
 DOME PROFILES (APPROX.)

**SHEET:**  
**AA4.01**


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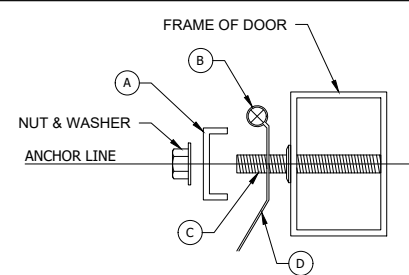
1 PLAN VIEW  
SCALE: 3/4" = 1'-0"

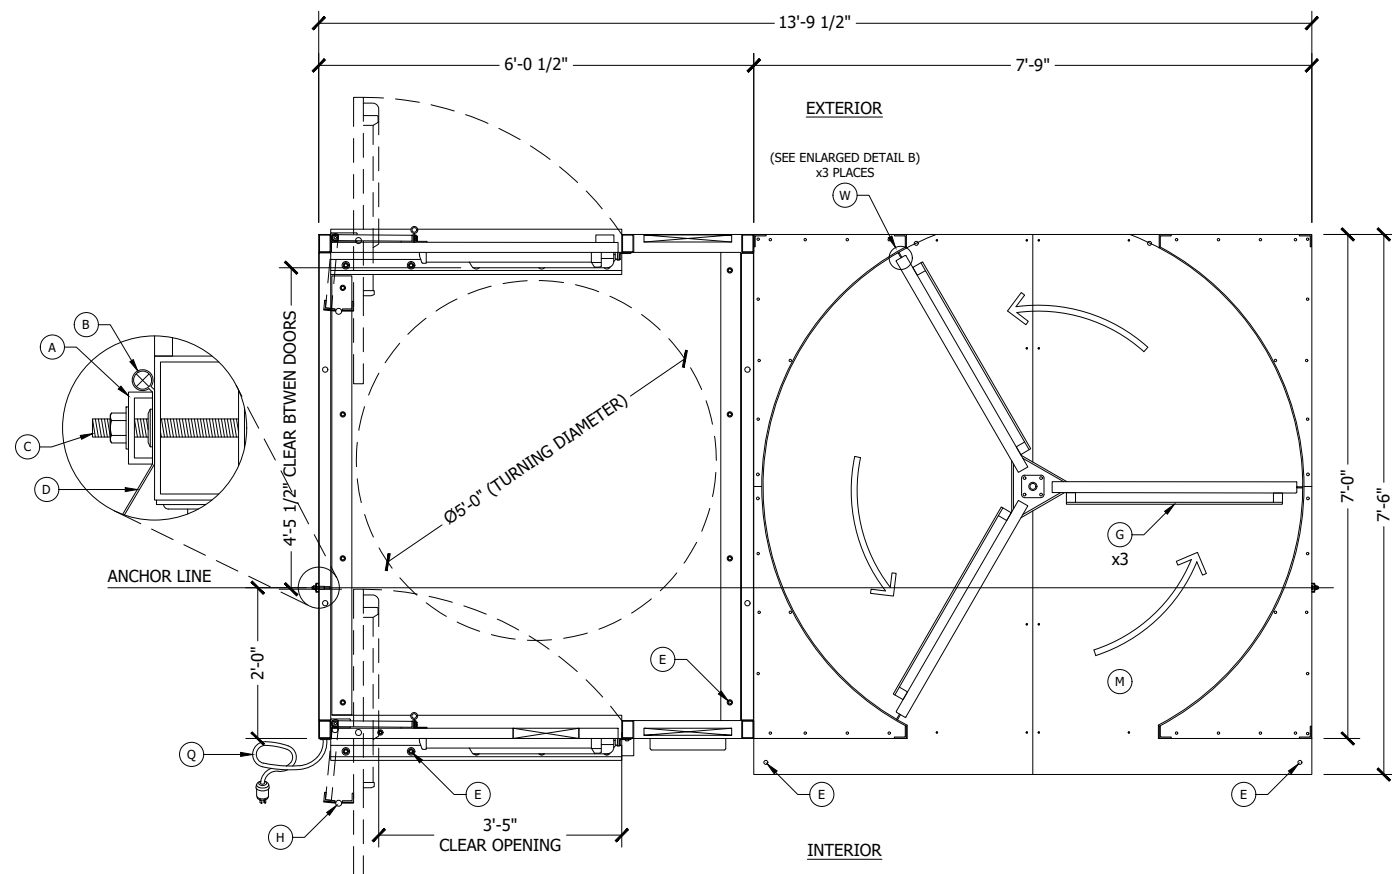


ALUMINUM THRESHOLD DETAIL (SIDE VIEW)

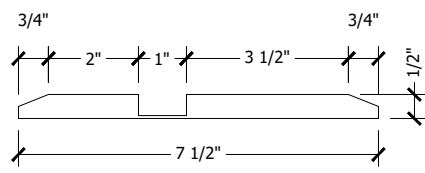


4 ISOMETRIC VIEW  
SCALE: N.T.S.

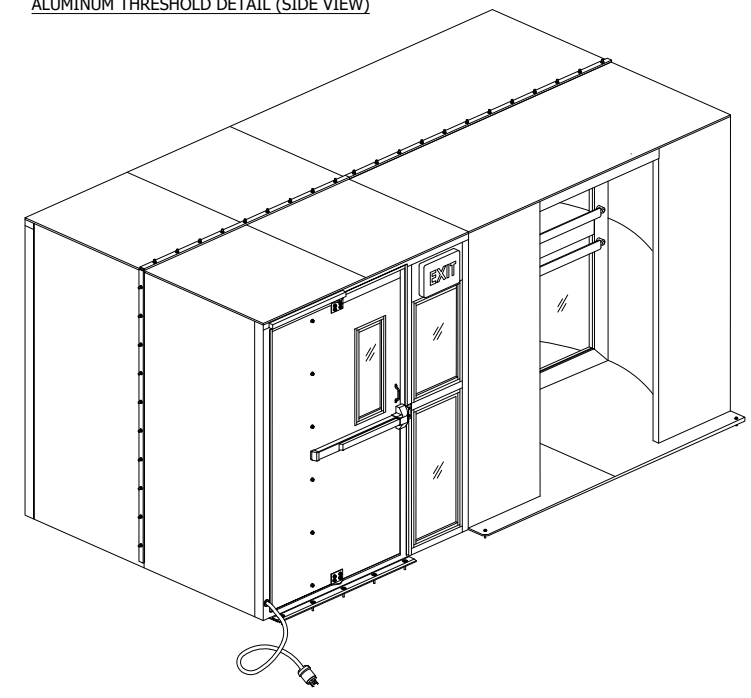


FABRIC INSTALLATION DETAIL

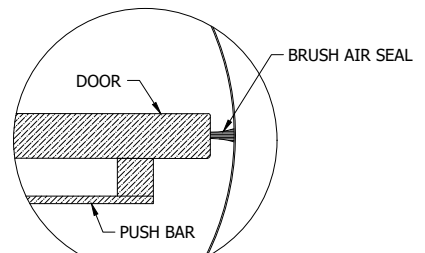


ENLARGED DETAIL B (BRUSH AIR SEALS)

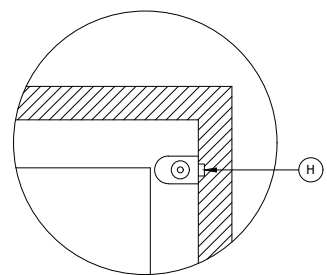

ENLARGED DETAIL A

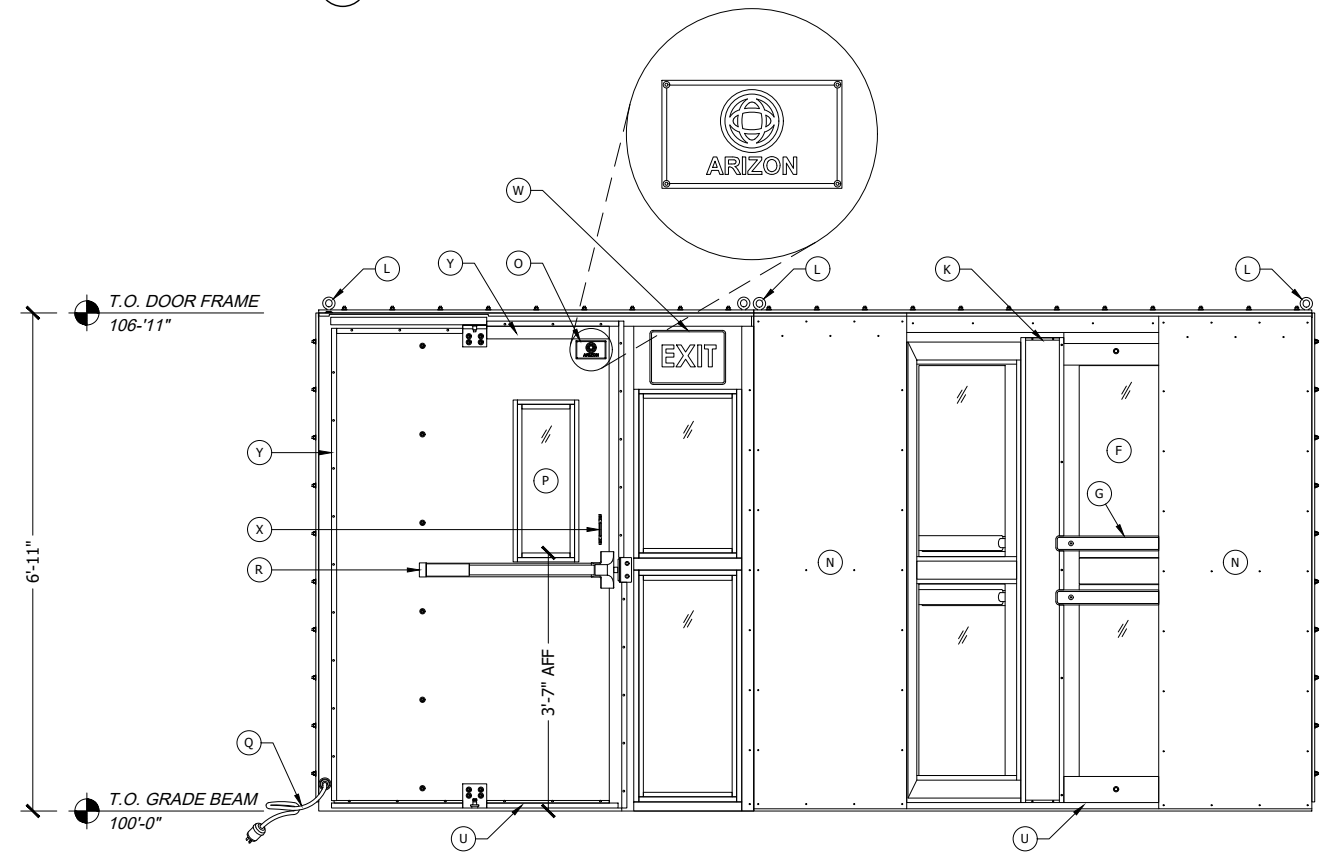

2 INTERIOR ELEVATION  
SCALE: 3/4" = 1'-0"

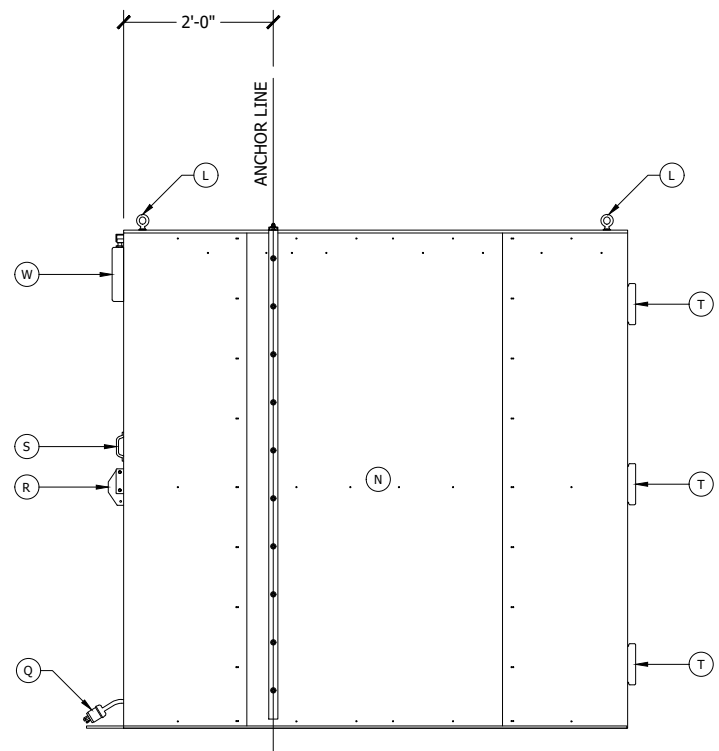

3 SIDE ELEVATION  
SCALE: 3/4" = 1'-0"

GENERAL NOTES:

1. REVOLVING DOOR / PERSONAL AIRLOCK COMBO
2. APPROXIMATE SHIPPING WEIGHT - 2,200 LBS
3. ALUMINUM CONSTRUCTION

KEYED NOTES:

- A. FABRIC CLAMP CHANNEL
- B. ROPE EDGE
- C. THREADED STUD WITH NUT, WASHER
- D. FABRIC MEMBRANE
- E. 1/2" CONCRETE ANCHORS (22 TOTAL)  
(4) ANCHORS / REVOLVING DOOR  
(18) ANCHORS / PERSONAL AIR LOCK
- F. FULL LENGTH GLAZING PANEL
- G. PUSH BARS (SEE ENLARGED DETAIL B)
- H. DEADBOLT DOUBLE CYLINDER LOCK  
(SEE ENLARGED DETAIL A)
- I. FLANGED BEARINGS W/ GREASE FITTINGS
- J. LOW DRAG AIR SEALS
- K. REMOVABLE SERVICE PANEL
- L. REMOVABLE LIFTING EYES
- M. NON-SLIP TREADPLATE FLOORING
- N. CLEAR ANODIZED SKIN
- O. 5" x 7" ARIZON SIGN
- P. VISION PANEL
- Q. EXIT SIGN POWER CORD - 3 PIGTAIL AT HINGE SIDE OF DOOR FRAME (120V POWER)
- R. PANIC HARDWARE (INTERIOR SIDE)
- S. LOCKABLE LEVER HANDLE (ENTRY SIDE)
- T. ADJUSTABLE SPRING HINGES
- U. BRUSH AIR SEALS AT FLOOR
- V. ILLUMINATED EMERGENCY SIGN & LIGHTS WITH BATTERY BACKUP (PER IBC 1011 AND 1011.6.3)
- W. BRUSH AIR SEALS (SEE ENLARGED DETAIL B)
- X. PULL HANDLE
- Y. RUBBER SEALS AT TOP AND SIDES

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 Dan Nordale  
 8700 SE 71st Street  
 Mercer Island, WA 98040  
 Tel: (206) 295-3687

JOB SITE ADDRESS:  
 8700 SE 71st Street  
 Mercer Island, WA 98040


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**CASE**  
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 F 316.349.1730  
 CERTIFICATE OF AUTHORITY NO. 4002

⚠	UPDATED FROM SITE SURVEY AND NETTING REVISIONS	C JORDAN
⚠	ISSUED FOR SUBMITTAL	C JORDAN

**SUBMITTALS / REVISIONS**

PROJECT NO:  
 A10396  
 PROJECT:  
 MERCER ISLAND COUNTRY CLUB  
 4 COURT TENNIS DOME

SCALE:  
 ANSI-B SIZE: 3/8"=1'-0"  
 ANSI-D SIZE: 3/4"=1'-0"

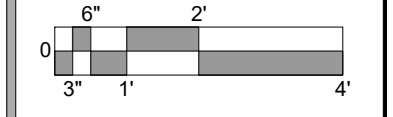

DRAWING TITLE:  
 MAIN ENTRY DOOR DETAILS  
 (3-LEAF REVOLVING DOOR WITH PERSONNEL AIRLOCK)

SHEET:

**NOT FOR CONSTRUCTION**


**AD1.01**

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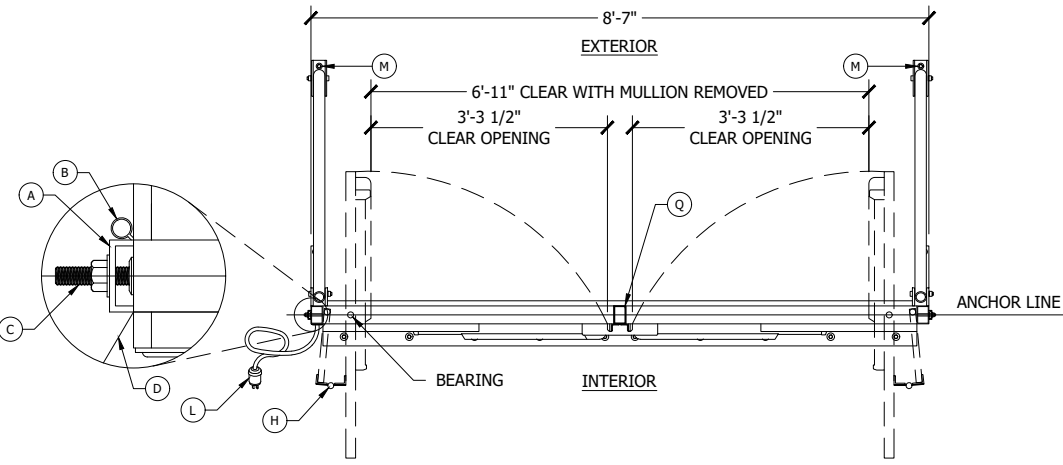
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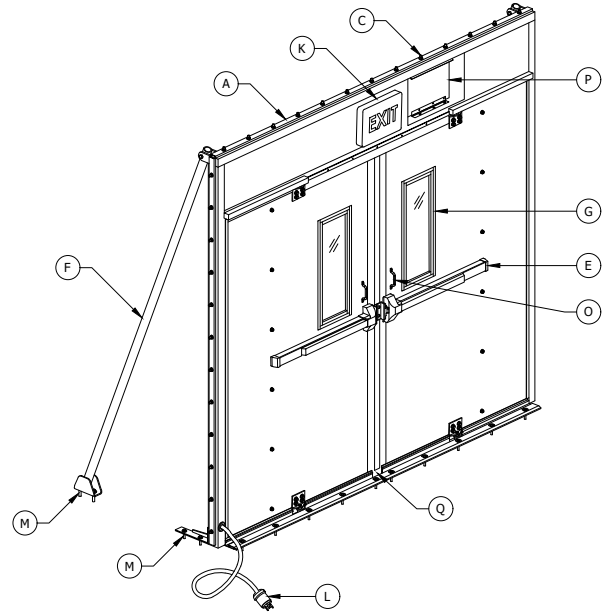
**JOB SITE ADDRESS:**  
8700 SE 71st Street  
Mercer Island, WA 98040



FABRIC INSTALLATION DETAIL

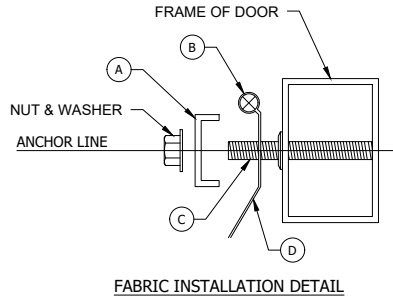


1 PLAN VIEW  
SCALE: 3/4" = 1'-0"




5 ISOMETRIC VIEW  
SCALE: N.T.S.

- GENERAL NOTES:**
- APPROXIMATE SHIPPING WEIGHT 250 LBS
  - ANODIZED ALUMINUM CONSTRUCTION (CLEAR)
  - MANUFACTURING OF DOORS SUBJECT TO CHANGE


- KEYED NOTES:**
- A. FABRIC CLAMP CHANNEL
  - B. ROPE EDGE
  - C. THREADED STUD WITH NUT, WASHER
  - D. FABRIC MEMBRANE
  - E. PANIC HARDWARE (TELL 8300 SERIES)
  - F. SUPPORT LEGS, 1.9" ALUMINUM PIPE
  - G. VISION PANEL - 2 PANES OF 1/8" THICK TEMPERED GLASS. 3/4" TOTAL THICKNESS - COMPLIANT WITH THE REQUIREMENTS OF IBC 2012 2406.4.1.
  - H. ADJUSTABLE SPRING HINGES
  - I. KEY LOCK AND PULL
  - J. EXTERIOR REMOTE HEAD FIXTURE (SHIPPED LOOSE FOR INSTALLATION BY THE ELECTRICAL CONTRACTOR (MODEL WCEM-2)
  - K. ILLUMINATED EXIT SIGN & LIGHTS WITH BATTERY BACKUP PER IBC 1011 AND 1011.6.3
  - L. EXIT SIGN POWER CORD - 3 FOOT PIGTAIL AT HINGE SIDE OF DOOR FRAME (120V POWER)
  - M. 1/2" CONCRETE ANCHOR (18 TOTAL)
  - N. 3" X 5" ARIZON SIGN
  - O. PULL HANDLE
  - P. TRANSOM VENT
  - Q. REMOVABLE CENTER MULLION

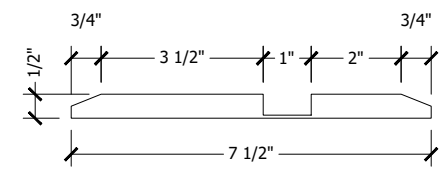


ALUMINUM THRESHOLD DETAIL (SIDE VIEW)

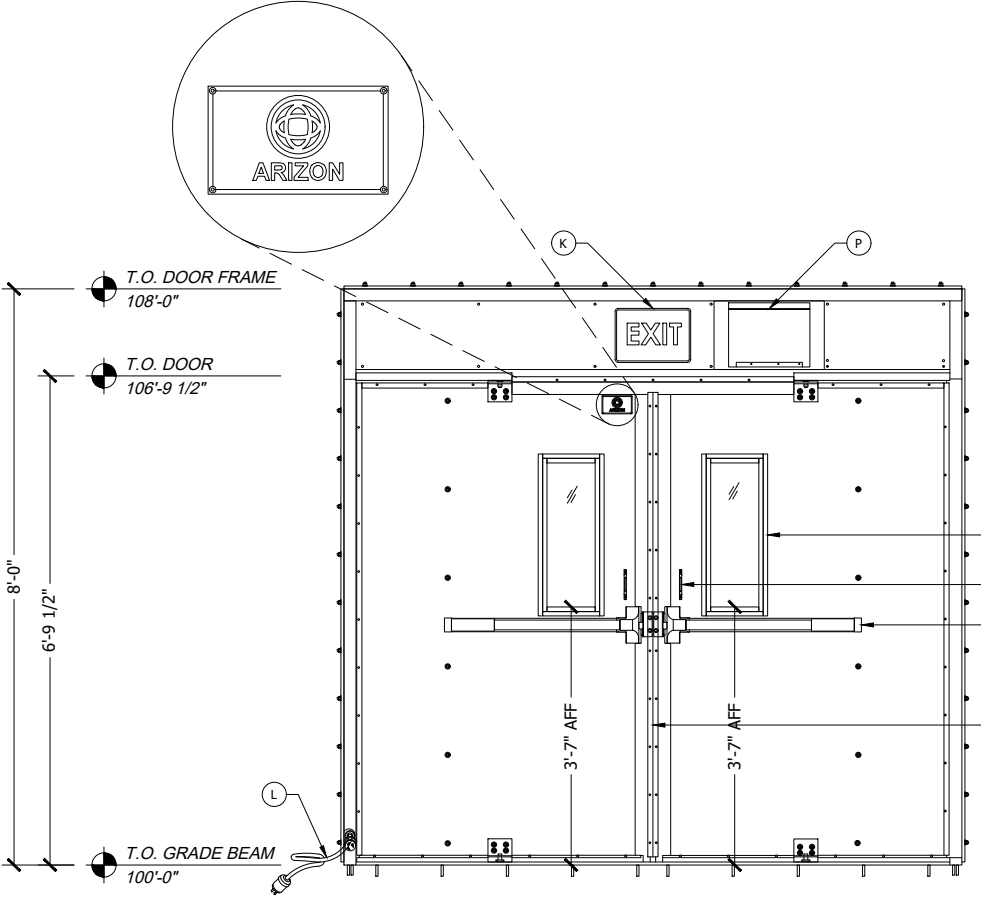

2 INTERIOR ELEVATION  
SCALE: 3/4" = 1'-0"

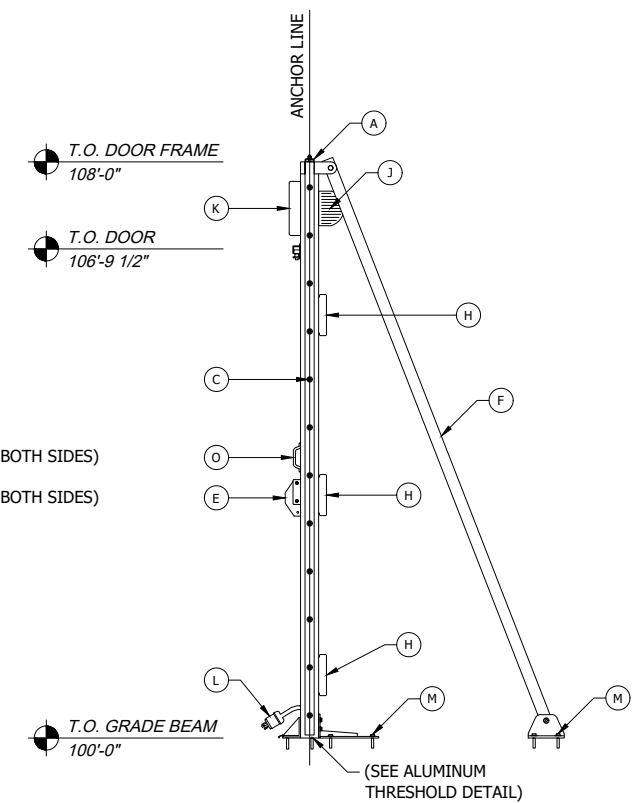

3 SIDE ELEVATION  
SCALE: 3/4" = 1'-0"

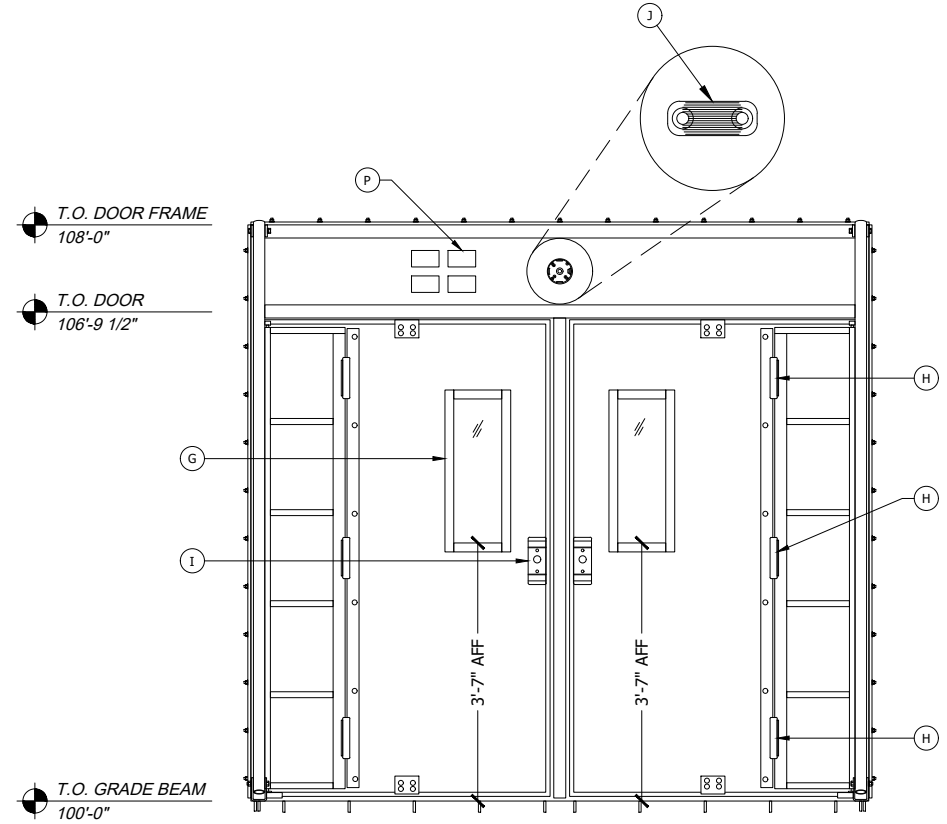

4 EXTERIOR ELEVATION  
SCALE: 3/4" = 1'-0"


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⚠	ISSUED FOR SUBMITTAL	C JORDAN 02-04-2022

**SUBMITTALS / REVISIONS**

**PROJECT NO:**  
A10396

**PROJECT:**  
MERCER ISLAND COUNTRY CLUB  
4 COURT TENNIS DOME


**SCALE:**  
ANSI-B SIZE: 3/8"=1'-0"  
ANSI-D SIZE: 3/4"=1'-0"

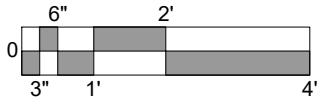


**DRAWING TITLE:**  
DOUBLE EMERGENCY  
EXIT DOOR DETAILS

**SHEET:**  
AD1.02

**NOT FOR CONSTRUCTION**

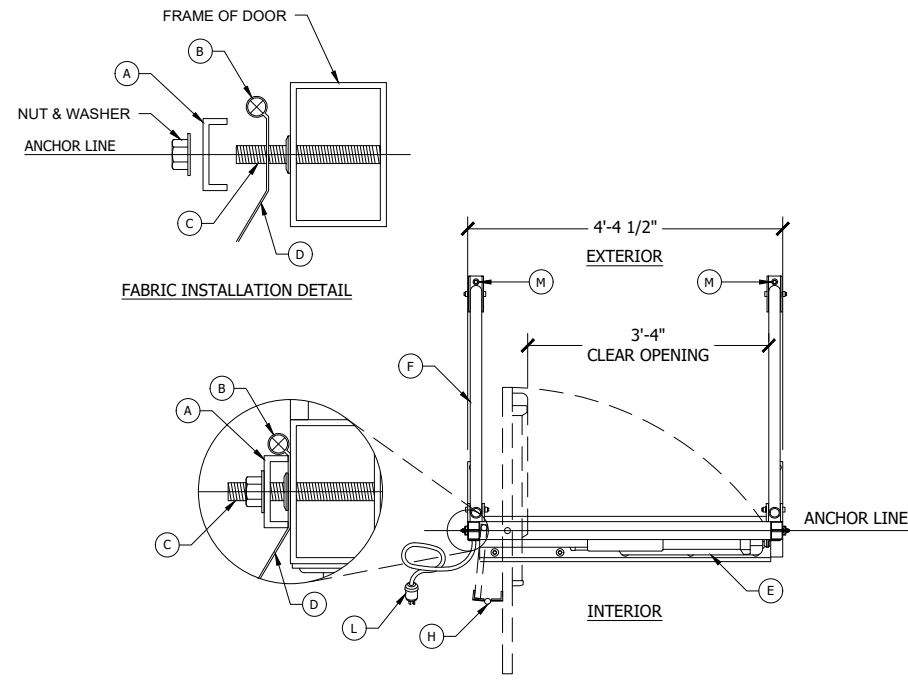


1 PLAN VIEW  
SCALE: 3/4" = 1'-0"

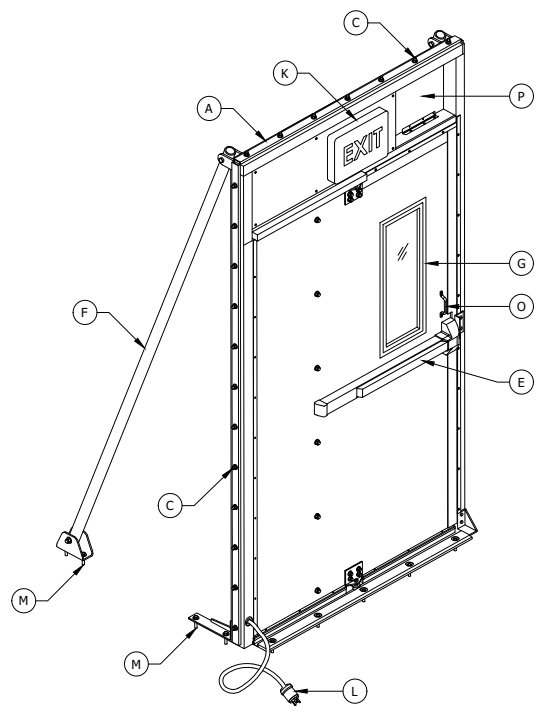


5 ISOMETRIC VIEW  
SCALE: N.T.S.

- GENERAL NOTES:
1. APPROXIMATE SHIPPING WEIGHT 250 LBS
  2. ANODIZED ALUMINUM CONSTRUCTION (CLEAR)
  3. MANUFACTURING OF DOORS SUBJECT TO CHANGE


- KEYED NOTES:
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  - B. ROPE EDGE
  - C. THREADED STUD WITH NUT, WASHER
  - D. FABRIC MEMBRANE
  - E. PANIC HARDWARE
  - F. SUPPORT LEGS, 1.9" ALUMINUM PIPE
  - G. VISION PANEL
  - H. ADJUSTABLE SPRING HINGES
  - I. KEY LOCK AND PULL
  - J. EXTERIOR REMOTE HEAD FIXTURE (SHIPPED LOOSE FOR INSTALLATION BY THE ELECTRICAL CONTRACTOR; MODEL VCCEM-2)
  - K. ILLUMINATED EMERGENCY SIGN & LIGHTS WITH BATTERY BACKUP (PER IBC 1011 AND 1011.6.3)
  - L. EXIT SIGN POWER CORD - 3 FOOT PIGTAIL AT HINGE SIDE OF DOOR FRAME (120V POWER)
  - M. 1/2" CONCRETE ANCHOR (13 TOTAL)
  - N. 3" X 5" ARIZON SIGN
  - O. PULL HANDLE
  - P. TRANSOM VENT

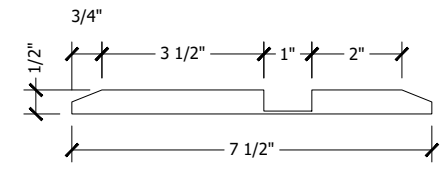


ALUMINUM THRESHOLD DETAIL (SIDE VIEW)

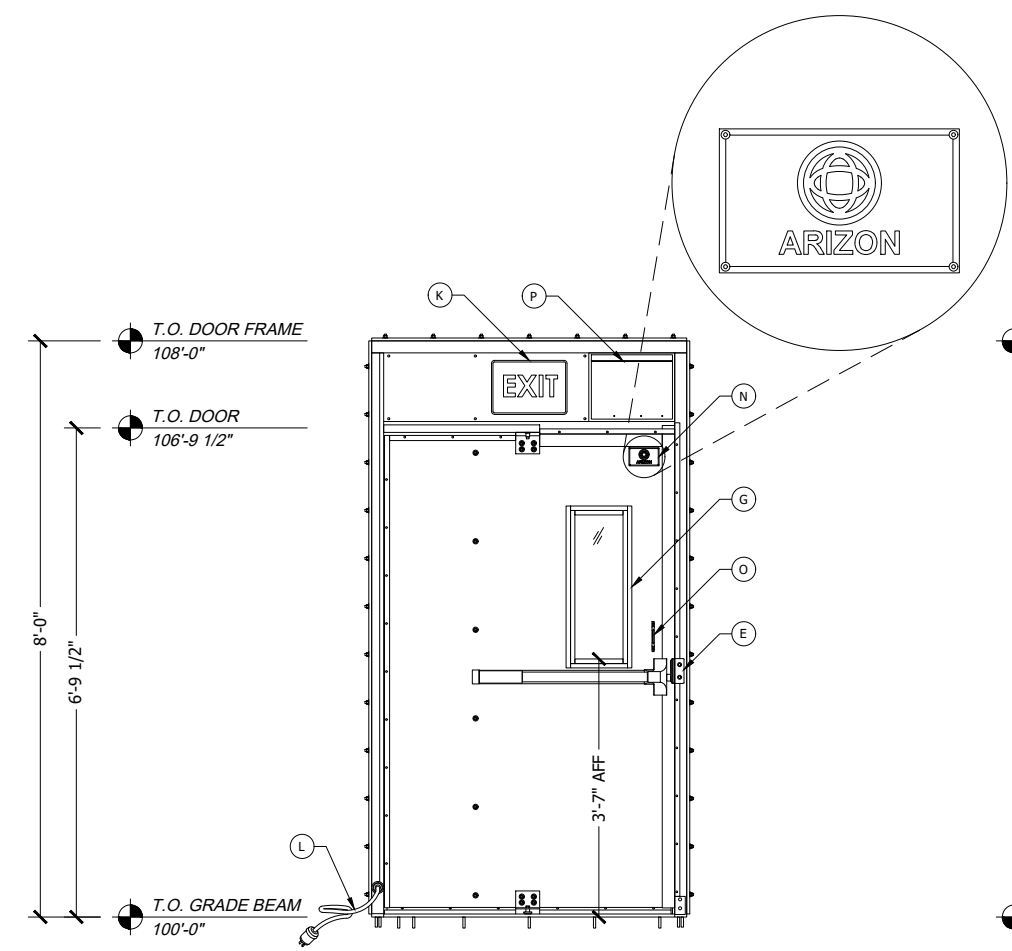

2 INTERIOR ELEVATION  
SCALE: 3/4" = 1'-0"

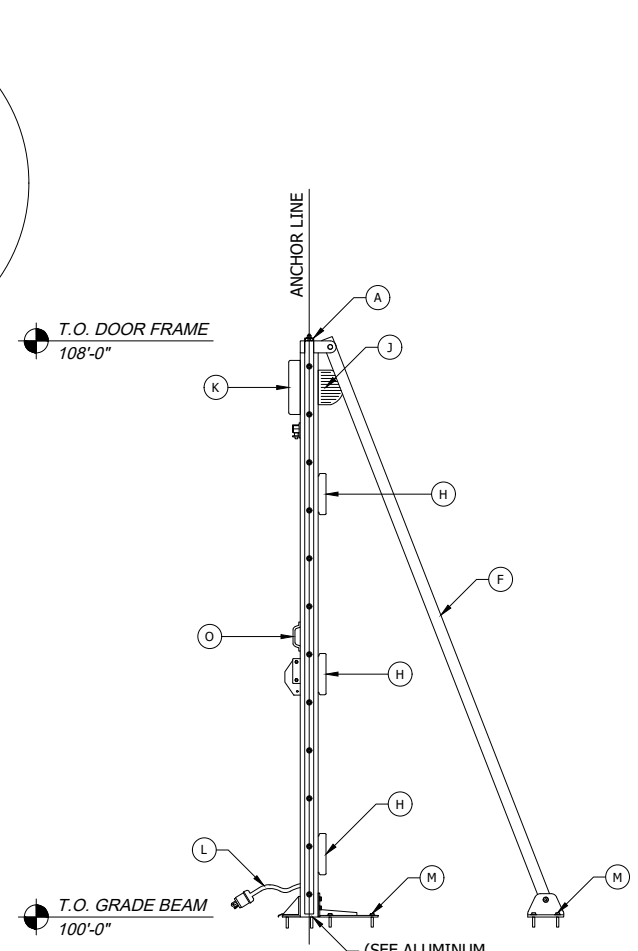

3 SIDE ELEVATION  
SCALE: 3/4" = 1'-0"

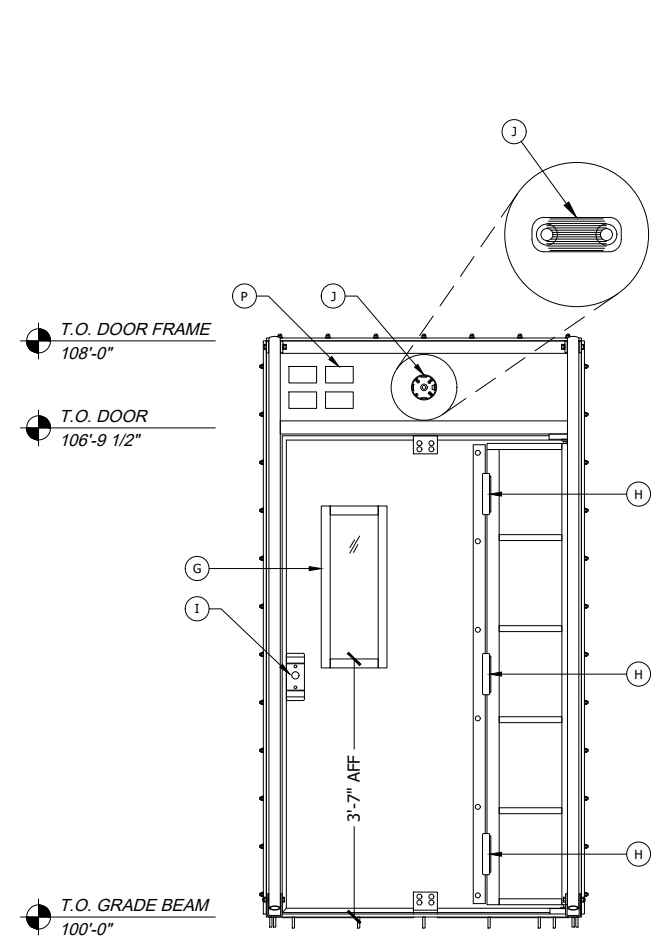

4 EXTERIOR ELEVATION  
SCALE: 3/4" = 1'-0"

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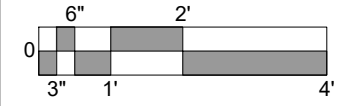
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MISSOURI  
**CASE**  
Engineering Inc.  
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St. Louis, MO 63026  
F 636.349.1600  
F 636.349.1730  
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**SUBMITTALS / REVISIONS**

PROJECT NO:  
A10396  
PROJECT:  
MERCER ISLAND COUNTRY CLUB  
4 COURT TENNIS DOME

SCALE:  
ANSI-B SIZE: 3/8"=1'-0"  
ANSI-D SIZE: 3/4"=1'-0"



DRAWING TITLE:  
SINGLE EMERGENCY EXIT DOOR  
WITH DIAGONAL BRACES DOOR  
DETAILS

SHEET:  
**AD1.03**

**NOT FOR CONSTRUCTION**





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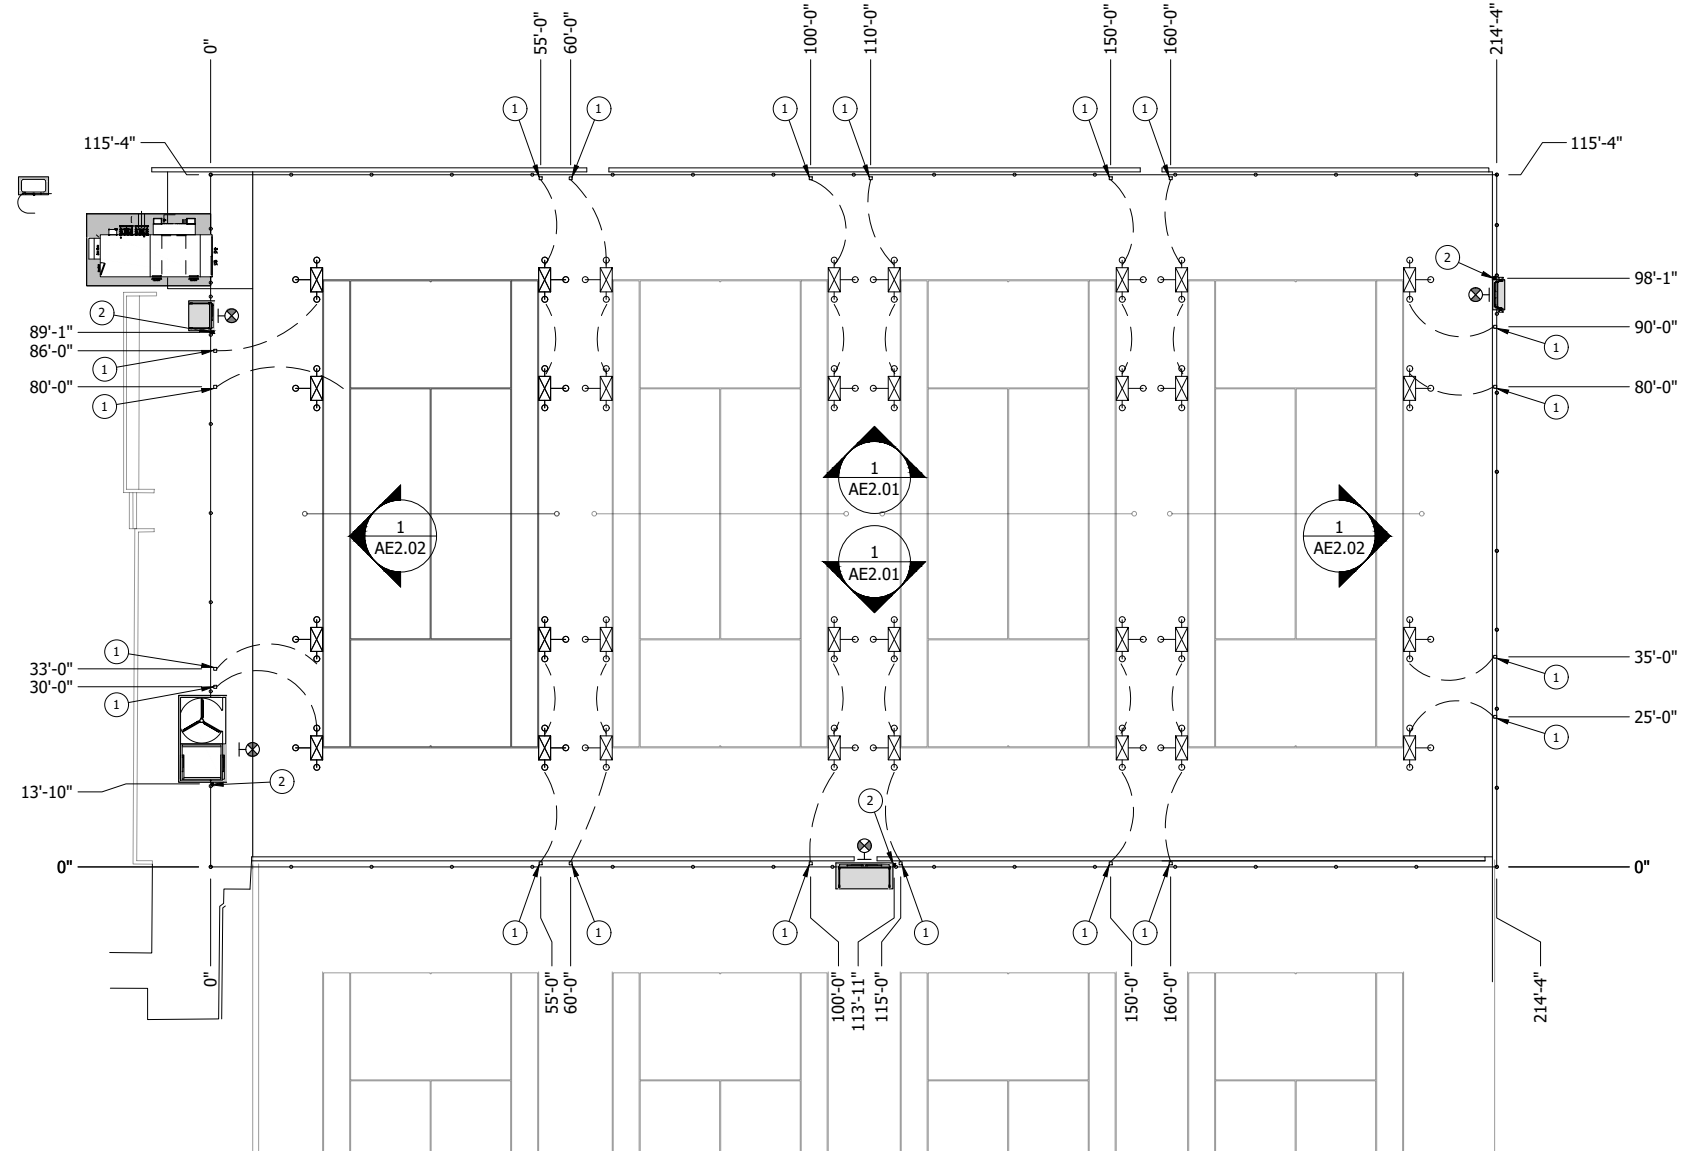
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 CERTIFICATE OF AUTHORITY NO. 4002



**KEYED NOTES**

- ① 120v, 1φ, 60Hz JUNCTION BOX WITH NEMA L7-15 TWIST-LOCK RECEPTACLE FOR PRIMARY LIGHTING
- ② 120v, 1φ, 60Hz JUNCTION BOX WITH NEMA L7-20 TWIST-LOCK RECEPTACLE FOR EXIT SIGN AND EXTERIOR REMOTE HEAD FIXTURE

**LEGEND**

- DOOR EXIT SIGN (INSTALLED BY OTHERS)
- LIGHT FIXTURE (DESIGNATION NO.)
- ELECTRICAL POWER CORD
- JUNCTION BOX
- CONCRETE

DRAWINGS SHOW EQUIPMENT WHICH WILL BE FURNISHED BY ARIZON OR BY OTHERS ARE NOT PART OF THE STRUCTURAL DESIGN OR ANALYSIS.

① **LIGHTING AND WIRING PLAN**  
 SCALE: 1/16" = 1'-0"


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⚠	ISSUED FOR SUBMITTAL	C JORDAN 02-04-2022

**SUBMITTALS / REVISIONS**

**PROJECT NO:**  
 A10396

**PROJECT:**  
 MERCER ISLAND COUNTRY CLUB  
 4 COURT TENNIS DOME

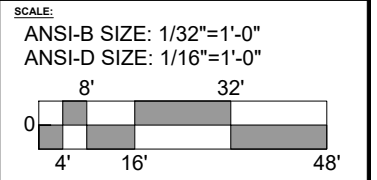

**DRAWING TITLE:**  
 LIGHTING AND WIRING PLAN

**SHEET:**  
**AE1.01**



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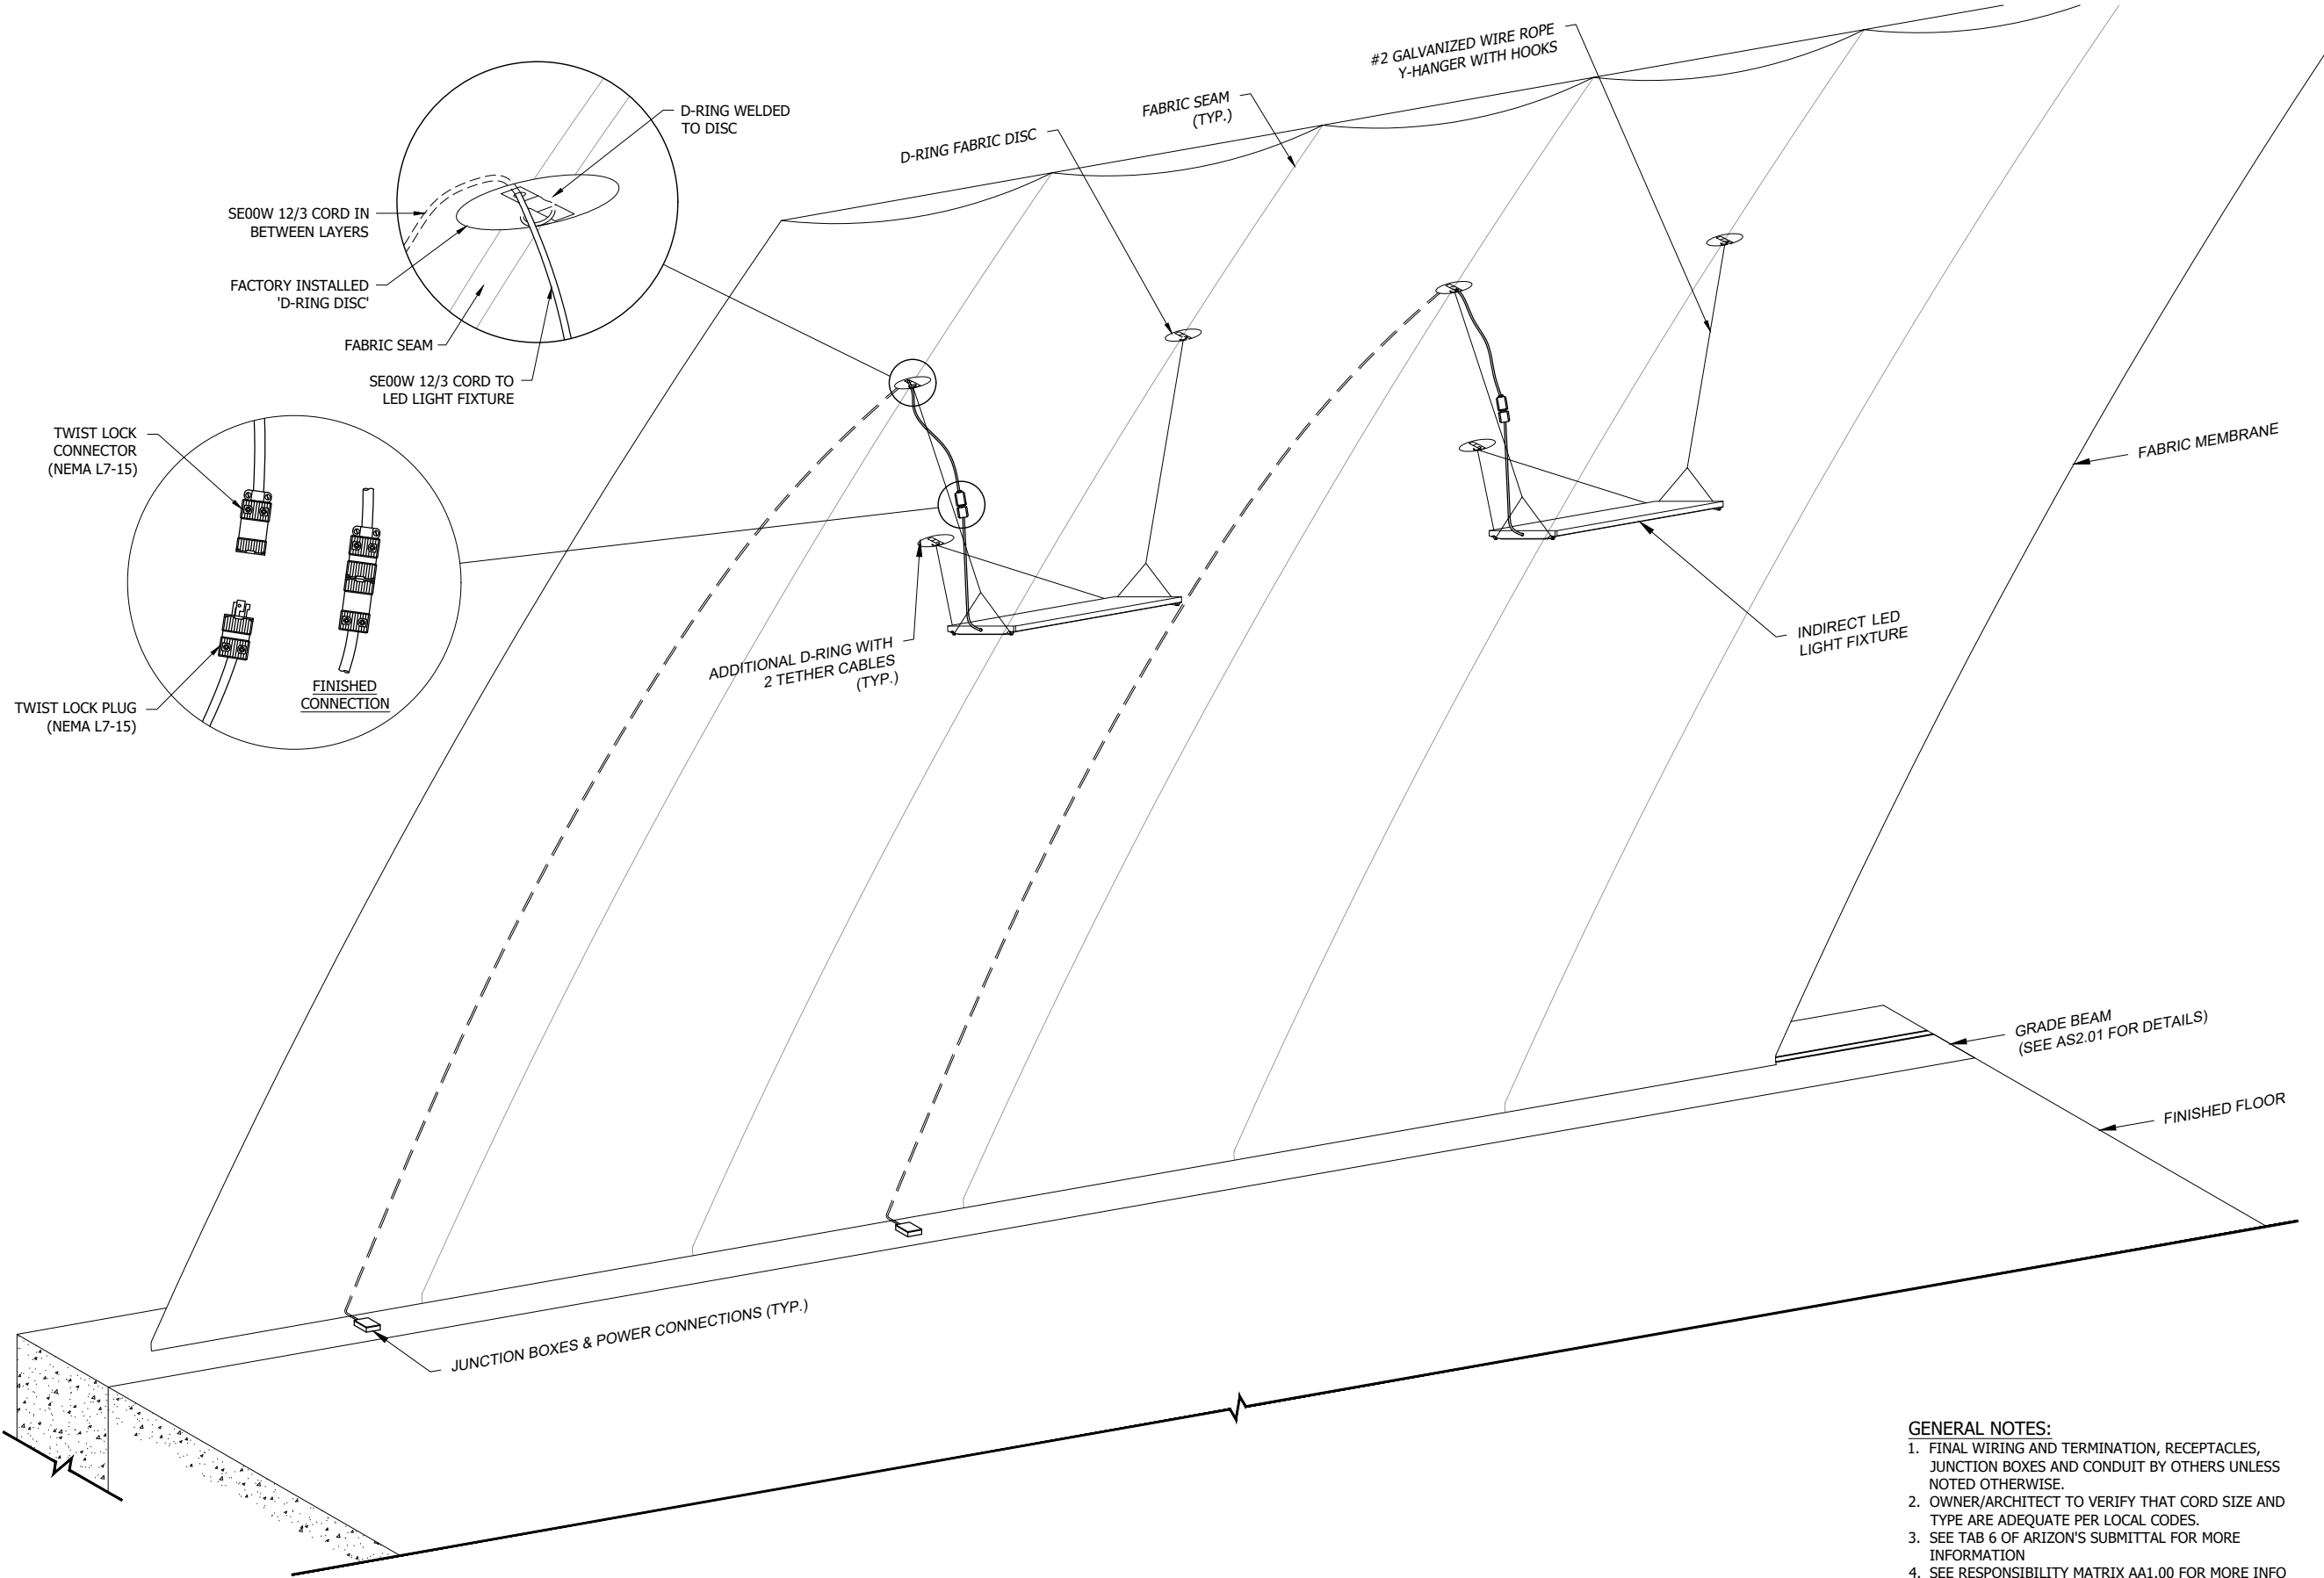
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**CASE**  
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796 Merens Court  
 St. Louis, MO 63026  
 T 316.349.1600  
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 CERTIFICATE OF AUTHORITY NO. 4002



- GENERAL NOTES:**
1. FINAL WIRING AND TERMINATION, RECEPTACLES, JUNCTION BOXES AND CONDUIT BY OTHERS UNLESS NOTED OTHERWISE.
  2. OWNER/ARCHITECT TO VERIFY THAT CORD SIZE AND TYPE ARE ADEQUATE PER LOCAL CODES.
  3. SEE TAB 6 OF ARIZON'S SUBMITTAL FOR MORE INFORMATION
  4. SEE RESPONSIBILITY MATRIX AA1.00 FOR MORE INFO

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0	ISSUED FOR SUBMITTAL	C JORDAN 02-04-2022

**SUBMITTALS / REVISIONS**

**PROJECT NO:**  
 A10396

**PROJECT:**  
 MERCER ISLAND COUNTRY CLUB  
 4 COURT TENNIS DOME

**SCALE:**  
 ANSI-B SIZE: 1/4"=1'-0"  
 ANSI-D SIZE: 1/2"=1'-0"

**DRAWING TITLE:**  
 LIGHT FIXTURE HANGING AND WIRING DETAILS

**SHEET:**  
 AE2.02



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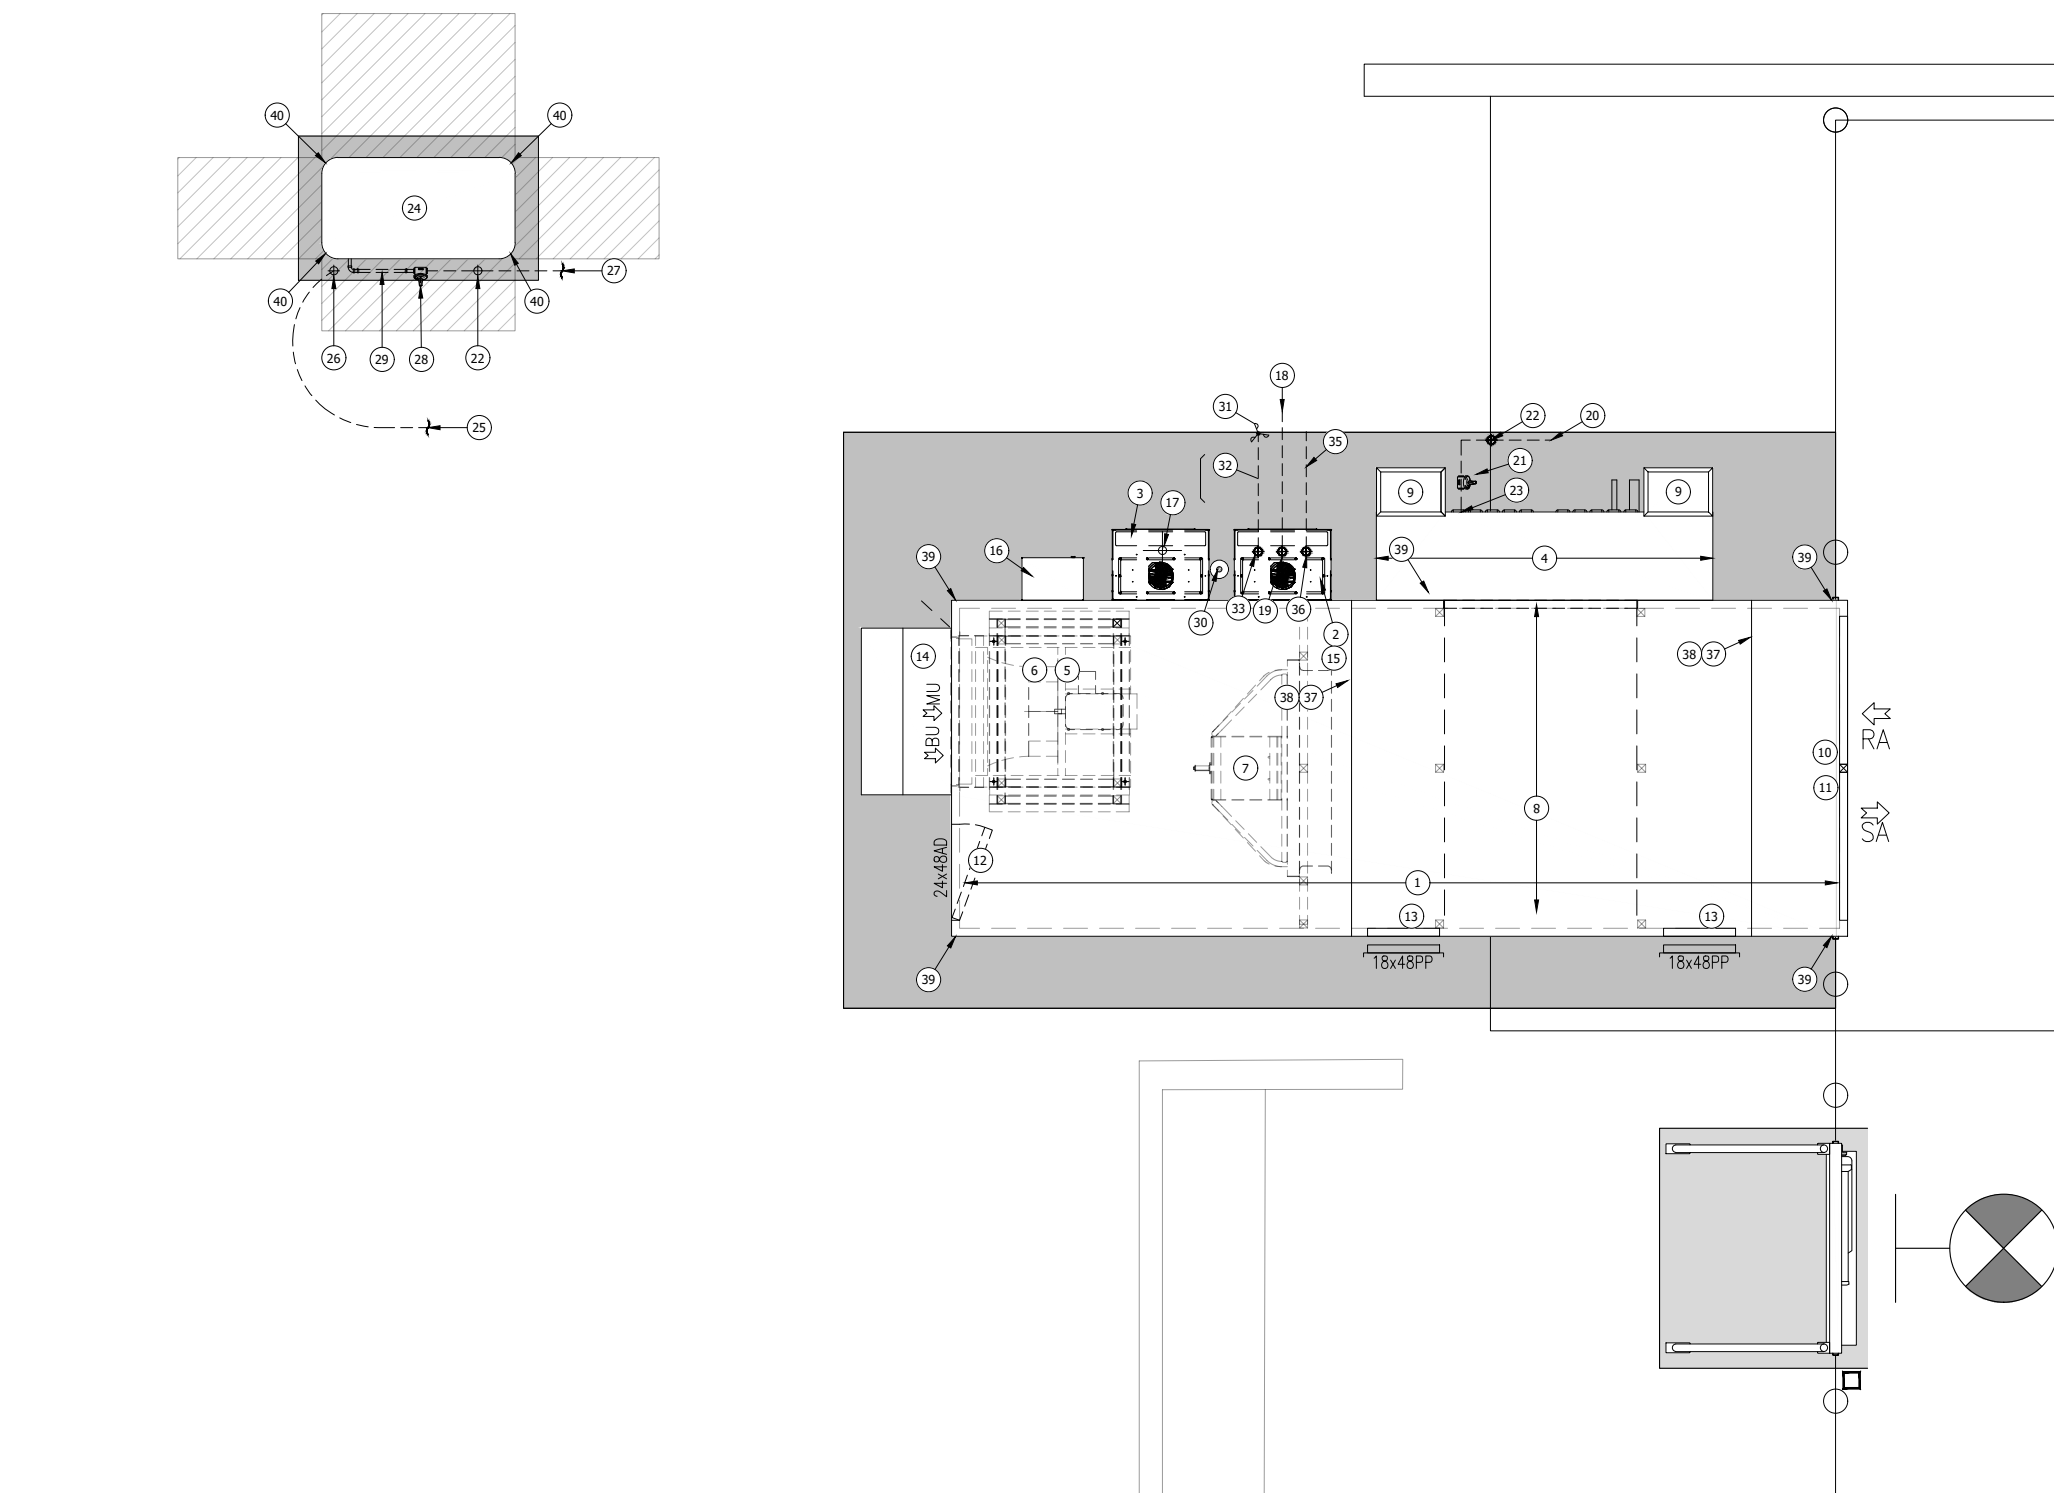


- KEYED NOTES:**
- AIR HANDLING UNIT (AHU)
  - PRIMARY ELECTRICAL AND CONTROLS CABINET
  - SECONDARY ELECTRICAL AND CONTROLS CABINET
  - BURNER CABINET
  - PRIMARY INFLATION FAN (BELOW)
  - BACKUP INFLATION FAN (ABOVE)
  - CIRCULATION FAN
  - HEAT EXCHANGER
  - HEATER EXHAUST FLUE PIPE
  - SUPPLY AIR DISCHARGE OPENING (ABOVE)
  - RETURN AIR INTAKE OPENING (BELOW)
  - ACCESS DOOR
  - PULL PANEL
  - RAIN HOOD
  - MAIN POWER DISTRIBUTION PANEL (BELOW)
  - TRANSFORMER (IF APPLICABLE)
  - AUTOMATIC TRANSFER SWITCH
  - PRIMARY ELECTRIC SERVICE TO AIR HANDLING UNIT (208v, 3φ, 60Hz)
  - STUB-UP FOR UNDERGROUND PRIMARY ELECTRIC SERVICE
  - PRIMARY NATURAL GAS SERVICE TO AIR HANDLING UNIT
  - NATURAL GAS REGULATOR FOR AIR HANDLING UNIT (BY OTHERS)
  - STUB-UP FOR UNDERGROUND NATURAL GAS SERVICE.
  - REGULATED GAS SUPPLY AT INLET TO AIR HANDLING UNIT MUST BE 2,000 BTU's AT 11 IN/W.C. MINIMUM, 14 IN/W.C. MAXIMUM.
  - BACK UP GENERATOR (18kW, 240v, 1φ, 60Hz) TO BE 20'-0" (MIN.) FROM DOME PER 2012 IFC 3104.19 SEPARATION OF GENERATORS
  - BACK UP ELECTRICAL SERVICE & CONTROLS WIRING
  - STUB-UP FOR UNDERGROUND NATURAL GAS
  - NATURAL GAS SERVICE TO GENERATOR
  - NATURAL GAS REGULATOR FOR GENERATOR (BY OTHERS)
  - REGULATED GAS SUPPLY AT INLET TO GENERATOR MUST BE 247,000 BTU's AT 3.5 IN/W.C. MINIMUM, 7 IN/W.C. MAXIMUM
  - SNOW SENSOR
  - WIND SENSOR (ANEMOMETER)(SEE NOTE 8)
  - WIND SENSOR CONTROL WIRING (BY OTHERS)
  - STUB-UP FOR UNDERGROUND WIND SENSOR CONTROL WIRING
  - REMOTE TOUCH SCREEN DISPLAY CONSOLE
  - REMOTE TOUCH SCREEN DISPLAY CONSOLE CONTROL WIRING (BY OTHERS)
  - STUB-UP FOR UNDERGROUND REMOTE DISPLAY CONSOLE WIRING
  - PRE-WIRED, COLOR CODED ELECTRICAL TERMINATIONS AT SHIPPING SPLITS. TERMINATIONS TO BE COMPLETED IN THE FIELD BY THE ELECTRICAL CONTRACTOR. TERMINATION BOXES MAY BE LOCATED ON THE INTERIOR OR EXTERIOR OF THE UNIT. ENSURE THAT ALL TERMINATIONS ARE COMPLETED PRIOR TO ENERGIZING THE EQUIPMENT.
  - MECHANICAL CONNECTIONS AT SHIPPING SPLITS TO BE COMPLETED BY THE INSTALLING MECHANICAL CONTRACTOR, ALL FASTENERS PROVIDED BY ARIZON. REFER TO THE EQUIPMENT I.O.M. FOR INSTALLATION INSTRUCTIONS FOR GASKET, TRIM STRIPS, AND SEALANT.
  - (1) ½" DIA. HILTI KWIK TZ STAINLESS STEEL STUD ANCHOR (3 1/4" MIN EMBED) AT EACH CORNER OF AIR HANDLING UNIT (TYP.).
  - (1) ¼" DIA. TAPCON ANCHOR (1 ½" MIN EMBED) AT EACH CORNER OF GENERATOR (TYP.).

- GENERAL NOTES:**
- REFERENCE THE PROJECT RESPONSIBILITY MATRIX ON SHEET AA1.00 FOR DETAILED INFORMATION REGARDING ARIZON'S SCOPE OF WORK.
  - INSTALLER TO DETERMINE AHU PLACEMENT BY ALIGNING CENTER LINE OF CLAMP CHANNEL WITH THE INSIDE EDGE OF THE ALUMINUM EXTRUSION
  - SEE TAB 6 OF THE SUBMITTAL FOR ADDITIONAL INFORMATION ON THE AIR HANDLING UNIT AND RELATED COMPONENTS.
  - SEE TAB 7 OF THE SUBMITTAL FOR ADDITIONAL INFORMATION ON THE BACKUP GENERATOR AND RELATED COMPONENTS.
  - ALL FIELD WIRING AND TERMINATIONS ARE TO BE FURNISHED AND INSTALLED BY THE INSTALLING ELECTRICAL CONTRACTOR PER ALL APPLICABLE CODES.
  - WIRING BETWEEN SHIPPING SECTIONS OF AIR HANDLING UNIT TO BE COMPLETED BY THE INSTALLING ELECTRICAL CONTRACTOR.
  - AIR HANDLING UNIT COMPONENTS SHOWN FOR SCHEMATIC REFERENCE ONLY. EXACT LOCATIONS MAY VARY.
  - ARIZON WILL PROVIDE 10 FEET OF EMT CONDUIT AND WIRES FOR TEMPORARY MOUNTING OF THE WIND SENSOR FOR INITIAL COMMISSIONING OF THE AIR HANDLING UNIT CONTROLS. THE OWNER'S ELECTRICIAN SHOULD RELOCATE THE SENSOR TO AN APPROPRIATE FINAL LOCATION BASED ON PREVAILING WIND CONDITIONS AT THE JOBSITE. INSTALLATION MUST BE IN STRICT ACCORDANCE WITH THE OEM'S INSTALLATION INSTRUCTIONS.

**LEGEND**

- (OR) SNOW SENSOR
- (OR) WIND SENSOR (ANEMOMETER)
- DISPLAY CONSOLE
- REMOTE DISPLAY CONSOLE
- NATURAL GAS REGULATOR
- SERVICE CLEARANCE ZONE
- CONCRETE



---NG--- NATURAL GAS SERVICE (BY OTHERS)    ---ELEC--- ELECTRICAL SERVICE (BY OTHERS)    ---CW--- CONTROL WIRING (BY OTHERS)

DRAWINGS SHOW EQUIPMENT WHICH WILL BE FURNISHED BY ARIZON OR BY OTHERS ARE NOT PART OF THE STRUCTURAL DESIGN OR ANALYSIS.

**1 ENLARGED MECHANICAL PAD PLAN**  
 SCALE: 1/2" = 1'-0"

**NOT FOR CONSTRUCTION**

	UPDATED FROM SITE SURVEY AND NETTING REVISIONS	C JORDAN 02-18-2022
	ISSUED FOR SUBMITTAL	C JORDAN 02-04-2022

**SUBMITTALS / REVISIONS**


**PROJECT NO:**  
 A10396

**PROJECT:**  
 MERCER ISLAND COUNTRY CLUB  
 4 COURT TENNIS DOME


**SCALE:**  
 ANSI-B SIZE: 1/4"=1'-0"  
 ANSI-D SIZE: 1/2"=1'-0"

**DRAWING TITLE:**  
 ENLARGED MECHANICAL  
 CONCRETE PAD PLAN


**SHEET:**  
**AM1.01**

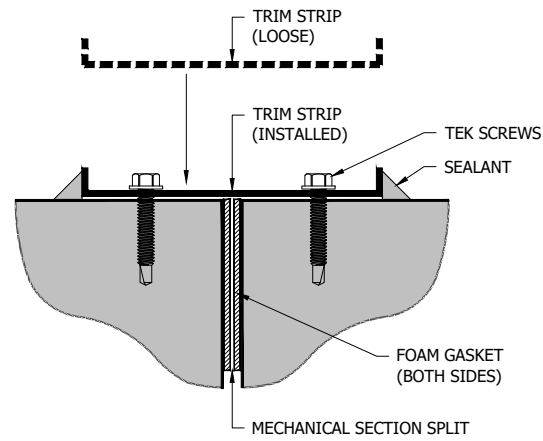

**A** TYP. AHU TRIM STRIP INSTALLATION DETAIL  
SCALE: N.T.S.

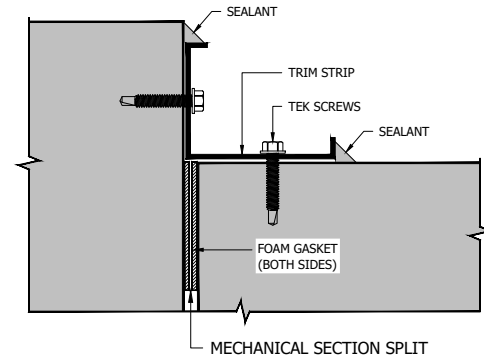

**B** TYP. AHU TRIM STRIP INSTALLATION DETAIL  
SCALE: N.T.S.

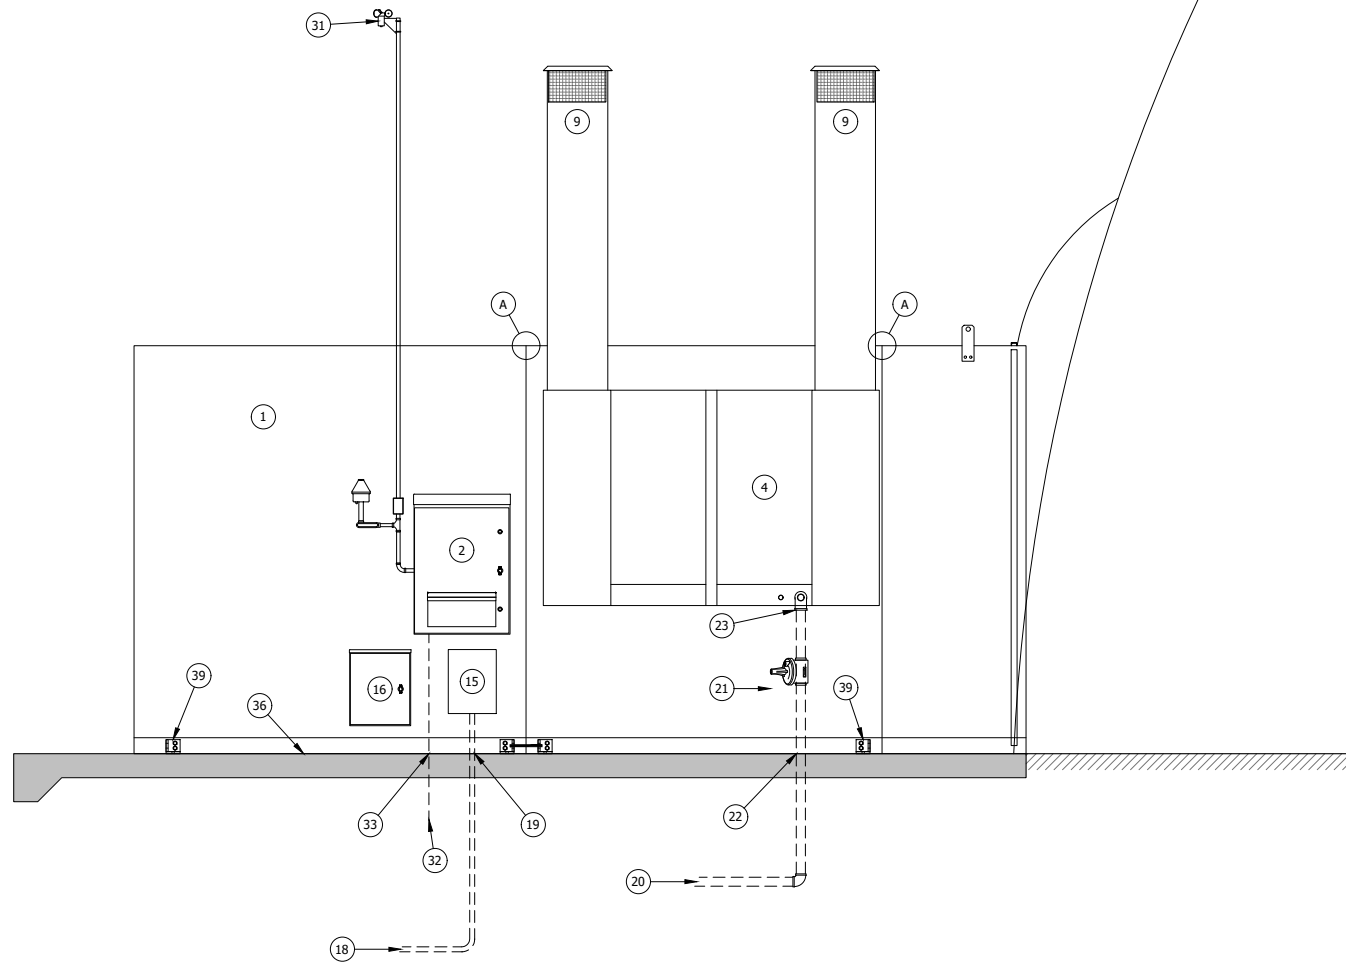

--NG-- NATURAL GAS SERVICE (BY OTHERS)    --ELEC-- ELECTRICAL SERVICE (BY OTHERS)    --CW-- CONTROL WIRING (BY OTHERS)

**1** ENLARGED ELEVATION AT AIR HANDLING UNIT  
SCALE: 1/2" = 1'-0"

DRAWINGS SHOW EQUIPMENT WHICH WILL BE FURNISHED BY ARIZON OR BY OTHERS ARE NOT PART OF THE STRUCTURAL DESIGN OR ANALYSIS.

**KEYED NOTES:**

1. AIR HANDLING UNIT (AHU)
2. PRIMARY ELECTRICAL AND CONTROLS CABINET
3. SECONDARY ELECTRICAL AND CONTROLS CABINET
4. BURNER CABINET
5. PRIMARY INFLATION FAN (BELOW)
6. BACKUP INFLATION FAN (ABOVE)
7. CIRCULATION FAN
8. HEAT EXCHANGER
9. HEATER EXHAUST FLUE PIPE
10. SUPPLY AIR DISCHARGE OPENING (ABOVE)
11. RETURN AIR INTAKE OPENING (BELOW)
12. ACCESS DOOR
13. PULL PANEL
14. RAIN HOOD
15. MAIN POWER DISTRIBUTION PANEL (BELOW)
16. TRANSFORMER (IF APPLICABLE)
17. AUTOMATIC TRANSFER SWITCH
18. PRIMARY ELECTRIC SERVICE TO AIR HANDLING UNIT (208v, 3φ, 60Hz)
19. STUB-UP FOR UNDERGROUND PRIMARY ELECTRIC SERVICE
20. PRIMARY NATURAL GAS SERVICE TO AIR HANDLING UNIT
21. NATURAL GAS REGULATOR FOR AIR HANDLING UNIT (BY OTHERS)
22. STUB-UP FOR UNDERGROUND NATURAL GAS SERVICE.
23. REGULATED GAS SUPPLY AT INLET TO AIR HANDLING UNIT MUST BE 2,000 BTU's AT 11 IN/W.C. MINIMUM, 14 IN/W.C. MAXIMUM.
24. BACK UP GENERATOR (18kW, 240v, 1φ, 60Hz) TO BE 20'-0" (MIN.) FROM DOME PER 2012 IFC 3104.19 SEPARATION OF GENERATORS
25. BACK UP ELECTRICAL SERVICE & CONTROLS WIRING
26. STUB-UP FOR UNDERGROUND NATURAL GAS
27. NATURAL GAS SERVICE TO GENERATOR
28. NATURAL GAS REGULATOR FOR GENERATOR (BY OTHERS)
29. REGULATED GAS SUPPLY AT INLET TO GENERATOR MUST BE 247,000 BTU's AT 3.5 IN/W.C. MINIMUM, 7 IN/W.C. MAXIMUM
30. SNOW SENSOR
31. WIND SENSOR (ANEMOMETER)(SEE NOTE 8)
32. WIND SENSOR CONTROL WIRING (BY OTHERS)
33. STUB-UP FOR UNDERGROUND WIND SENSOR CONTROL WIRING
34. REMOTE TOUCH SCREEN DISPLAY CONSOLE
35. REMOTE TOUCH SCREEN DISPLAY CONSOLE CONTROL WIRING (BY OTHERS)
36. STUB-UP FOR UNDERGROUND REMOTE DISPLAY CONSOLE WIRING
37. PRE-WIRED, COLOR CODED ELECTRICAL TERMINATIONS AT SHIPPING SPLITS. TERMINATIONS TO BE COMPLETED IN THE FIELD BY THE ELECTRICAL CONTRACTOR. TERMINATION BOXES MAY BE LOCATED ON THE INTERIOR OR EXTERIOR OF THE UNIT. ENSURE THAT ALL TERMINATIONS ARE COMPLETED PRIOR TO ENERGIZING THE EQUIPMENT.
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39. (1) 1/2" DIA. HILTI KWIK TZ STAINLESS STEEL STUD ANCHOR (3 1/4" MIN EMBED) AT EACH CORNER OF AIR HANDLING UNIT (TYP.).
40. (1) 1/4" DIA. TAPCON ANCHOR (1 1/2" MIN EMBED) AT EACH CORNER OF GENERATOR (TYP.).

**GENERAL NOTES:**

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- SERVICE CLEARANCE ZONE
- CONCRETE

**NOT FOR CONSTRUCTION**

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www.arizonbuildingsystems.com

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Dan Nordale  
8700 SE 71st Street  
Mercer Island, WA 98040  
Tel: (206) 295-3687

**JOB SITE ADDRESS:**  
8700 SE 71st Street  
Mercer Island, WA 98040



	UPDATED FROM SITE SURVEY AND NETTING REVISIONS	C JORDAN 02-18-2022
	ISSUED FOR SUBMITTAL	C JORDAN 02-04-2022

**SUBMITTALS / REVISIONS**

**PROJECT NO:**  
A10396

**PROJECT:**  
MERCER ISLAND COUNTRY CLUB  
4 COURT TENNIS DOME

**SCALE:**  
ANSI-B SIZE: 1/4"=1'-0"  
ANSI-D SIZE: 1/2"=1'-0"

**DRAWING TITLE:**  
ENLARGED MECHANICAL  
CONCRETE PAD ELEVATION

**SHEET:**  
**AM2.01**





**STRUCTURAL NOTES**

**General Notes:**

- Reference Standards: Unless otherwise noted, all standards shall be current edition, with latest addenda if applicable.
- Read these drawings in conjunction with all related contract documents and architectural, mechanical and electrical drawings.
- Contractor shall verify all dimensions, member sizes and field conditions prior to any fabrication, construction or installation and notify engineer if conditions, materials, sizes and dimensions are different from those shown.
- Details and conditions not specifically shown shall be constructed in accordance with details shown for similar conditions and material.
- Drawings are not to be scaled.
- By accepting these documents for construction, the owner hereby acknowledges the following:
  - The owner has read the owner's manual for operation and maintenance of the air structure.
  - The owner agrees to train all employees who will be in charge of the air structure in the correct care of the dome. The training will specifically emphasize adjusting the internal pressures for weather events
  - The owner shall record all changes in internal air pressure settings at the site and shall train all employees to also record all changes in internal air pressure settings.
- Code study and compliance with life safety issues (including but not limited to use of building, occupant load, travel distance, ingress, egress, fire rating/smoke control requirements, etc.) are the responsibility of the Owner.

**Codes:**

- International Building Code 2018
- ASCE 7-16
- ASCE 55-16 Tensile Membrane Structures

**Loads:**

- Wind Loads
  - Wind Speed = 110 mph (3 second gust)
  - Wind Exposure = "C"
  - Wind Importance Factor  $I_w = 1.0$
  - Arched Roof
- Snow Loads
  - Ground Snow Load  $P_g = 25$  psf
  - Flat Roof Snow Load  $P_f = 20.0$  psf
  - Curved Roof
  - Snow Exposure Factor  $C_e = 1.0$
  - Snow Importance Factor  $I_s = 1.0$
  - Thermal Factor  $C_t = 1.0$  (Building is heated but is not a greenhouse)
- Seismic Loads
  - Not a consideration for fabric structures
- Maximum Inflation Pressure = 1.8" w.c. = 9.36 psf

**Materials:**

- Concrete
  - 4,000 psi Slab on Grade, Mechanical Pads, Sidewalks, Door Stoops
  - 4,000 psi Grade Beams, Foundation Walls
  - 4,000 psi Footings
  - All concrete exposed to freeze thaw cycles shall have 5% - 7% air entrainment.
- Steel
  - 60,000 psi ASTM A615 Grade 60 Reinforcing
  - 75,000 psi ASTM A185 Welded Wire Fabric
  - 50,000 psi ASTM A992 "W" Shapes
  - 36,000 psi ASTM A36 Plates and Angles, etc.
  - 46,000 psi ASTM A500 Grade "B" Structural Tubes
  - 92,000 psi ASTM A325 High Strength Bolts
  - 50,000 psi ASTM F1554 Anchor Bolts Grade 55
- Cable
  - $\phi 1/2"$  cables shall be 6x25, Drawn Galvanized, Independent Wire Rope Core (IWRC), Extra Improved Plow (EIP), nylon coated, steel cables with minimum breaking strength as specified unless otherwise noted.
  - $\phi 3/8"$  cables shall be 6x19, Drawn Galvanized, Independent Wire Rope Core (IWRC), Extra Improved Plow (EIP), nylon coated, steel cables with minimum breaking strength as specified unless otherwise noted.
- Fabric
  - Load bearing fabric breaking strength = 500 lbs / in.(Warp)
- Shackles shall be similar to Crosby G-209 Series.

**General Foundation Notes:**

- All foundation excavations, backfill and compaction shall be inspected and certified by a qualified soils testing firm prior to the construction of any footings. All reports are to be submitted to structural engineer.
- Unless noted otherwise in the soils report, earth fill placement shall be compacted to a dry density of not less than 95% of the standard proctor, and well graded granular fill shall be compacted to dry density of not less than 100% of the standard proctor. Fill shall be placed in layers not exceeding a loose thickness of 8 inches.
- Furnish #4 and #5 continuous wall footing reinforcing in stock lengths. Field bend #4 around corners and through footing steps. Shop bend #5 through footing steps and around corners. Lap continuous footing reinforcing per ACI guidelines but not less than 15" and stagger all splices.
- Cast dowels in footings for concrete columns and walls above. Dowels to be same number and size as the vertical reinforcing, unless noted otherwise. Dowels are to project from footings 30 bar diameters or a minimum of 24" whichever is greater. Provide 90 degree bend in column footing dowels. Wall footing dowels are straight, unless noted otherwise.
- Shore all foundation walls before backfilling and compacting.
- Concrete footings placed in earth trenched forms shall be free from standing water and frost. Concrete footings shall be protected from freezing for a period of not less than 5 days.
- Provide 6x6 W1.4xW1.4 W.W.F. (6x6 10/10 W.W.F.) on all slabs on grade and entrance platforms, unless noted otherwise.

**General Concrete Notes:**

- Standards
  - ACI 318 "Building Code" requirement for reinforced concrete.
  - ACI 315 "Manual of Standard Practice" for detailing reinforcing for concrete structures.
  - ACI 347 "Recommended Practice for Concrete Formwork"
  - ACI 304 "Recommended Practice for Measuring, Mixing, Transporting and Placing Concrete"
  - ACI 309 "Recommended Practice for Consolidation of Concrete" (ACI 309-72)
  - ACI 308 "Recommended Practice for Curing Concrete"
  - ACI 306 "Recommended Practice for Cold Weather Concrete"
  - ACI 305 "Recommended Practice for Hot Weather Concrete"
- Reinforcing supplier to provide all accessories, chairs, spacing bars and supports necessary to secure steel in accordance with the most recent edition of the "Manual so Standard Practice" by the Concrete Reinforcing Steel Institute.
- Supplier shall provide plastic chairs and bar supports in all areas of exposed concrete.
- Provide minimum concrete protection for all reinforcement as follows:
  - Cast against and permanently exposed to earth = 3"
  - Exposed to earth or weather:
    - #5 bars and smaller - 1 1/2"
    - #6 bars and larger - 2"
  - Not exposed to weather or in contact with ground:
    - Slabs, walls & joists (#3 to #11 bars) = 3/4"
    - Beams, girders & columns, main reinforcement, ties, stirrups or spirals = 1 - 1/2"
  - Provide corner bars at all walls, grade beams and edge beams. Corner bar to be the same size and spacing as all horizontal bars.
  - At openings in slabs or walls, provide a minimum of two #6 bars each side of opening, bars to be 6'-0" longer than the opening.
  - At openings in slabs or walls, provide a minimum of two #6 bars each side of opening.
  - Provide minimum concrete wall reinforcing as follows: (unless noted otherwise)
    - 6" & 8" concrete walls: #4 @ 16" O.C. vert. & #4 @ 10" horiz. (center in wall)
    - 10" concrete walls: #4 @ 16" O.C. vert. & #4 @ 16" horiz. (each face)
    - 12" concrete walls: #4 @ 16" O.C. vert. & #4 @ 12" horiz. (each face)
    - 16" concrete walls: #4 @ 16" O.C. vert. & #4 @ 12" horiz. (each face)
  - No aluminum of any type shall be allowed in the concrete work, unless coated to prevent aluminum concrete reaction.
  - Maximum outside diameter of embedded conduit shall be no larger than 1/3 of the slab thickness and the conduit shall be placed such that it does not significantly impair the strength of construction.

**General Steel Notes:**

- Construction of structural steel shall comply with all the requirements of AISC "Specifications for Structural Steel for Buildings Allowable Stress Design and Plastic Design".
- All welds shall be per the latest edition of the specifications of the AWS. E70xxx electrodes.
- Post installed anchors in concrete or masonry shall be ICC approved for use in cracked concrete. Approved anchors shall be Hilti Kwik Bolt TZ Expansion Anchors or a Hilti HIT-RE 500-SD Safe Set System, unless noted otherwise. Install anchors in strict conformance with anchor manufacturer's instructions. **NO ANCHORS SHALL BE INSTALLED WITHOUT THE WRITTEN CONSENT OF THE ENGINEER!**
- All steel beams shall be true to line and elevation, column base plates grouted and anchor bolts tight before any loads are placed.
- All column base and cap plates shall be welded around all sides.
- All welds not specified are 3/16" fillet weld, continuous and/or all around.

**General Notes for Hilti Post-Installed Anchors:**


- Adhesive anchors for cracked and uncracked concrete use:
- Hilti HIT-HY 200 Safe set system with Hilti hollow drill bit (TE-CD or TE-YD) and VC20/40 vacuum (VC 20-U or VC 40-U) system with continuously deformed rebar per ICC ESR-3187.
  - Hilti HIT-HY 500 V3 Safe set system with Hilti hollow drill bit (TE-CD or TE-YD) and VC20/40 vacuum (VC 20-U or VC 40-U) system with continuously deformed rebar per ICC ESR-3814.

Anchor capacity used in design shall be based on the technical data published by Hilti or such other method as approved by the structural engineer of record, substitution requests for alternate products must be approved in writing by the structural engineer of record prior to use. Contractor shall provide calculations demonstrating that the substituted product is capable of achieving the performance values of the specified product. Substitutions will be evaluated by their having an ICC ESR showing compliance with the relevant building code for seismic uses, load resistance, installation category, and availability of comprehensive installation instructions. Adhesive anchor evaluation will also consider creep, in-service temperature and installation temperature.



Install anchors per the manufacturer instructions, as included in the anchor packaging.

Anchor capacity is dependant upon spacing between adjacent anchors and proximity of anchors to edge of concrete. Install anchors in accordance with spacing and edge clearances indicated on the drawings.


Existing reinforcing bars in the concrete structure may conflict with specific anchor locations. Unless noted on the drawings that the bars can be cut, the contractor shall review the existing structural drawings and shall undertake to locate the position of reinforcing bars at the locations of the concrete anchors, by Hilti ferrosacan, GPR, X-ray, chipping or other means.

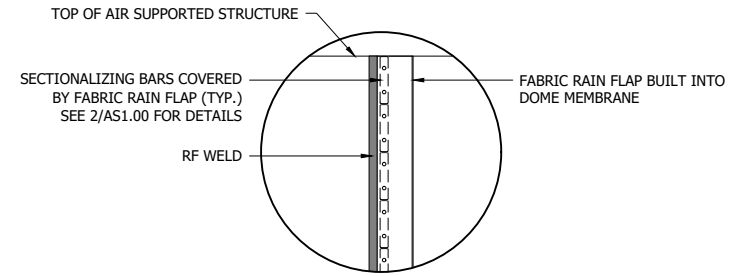


**4 SECT'L RAIN FLAP DETAIL**  
SCALE: 1/2" = 1'-0"

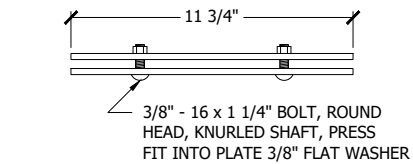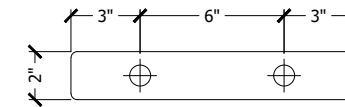

**3 SECTIONALIZING BAR**  
SCALE: 3" = 1'-0"

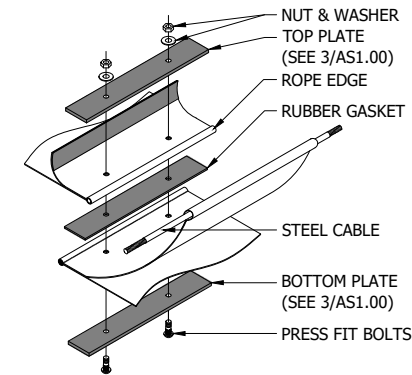

**2 SECTIONALIZING ASSEMBLY DETAIL**  
SCALE: 1 1/2" = 1'-0"

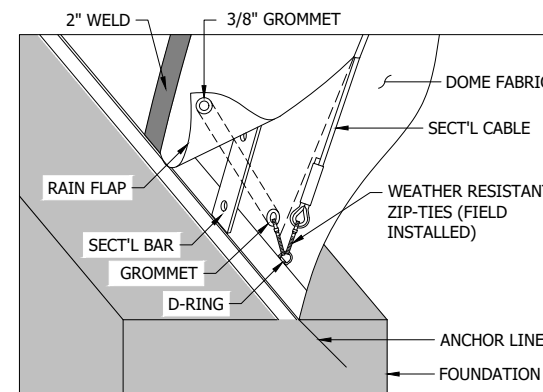

**1 RAIN FLAP ANCHOR DETAIL**  
SCALE: 1 1/2" = 1'-0"

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**JOB SITE ADDRESS:**  
8700 SE 71st Street  
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**ENGINEER:**  
MISSOURI  
**CASE**  
Engineering Inc.  
796 Meno Court  
St. Louis, MO 63026  
T 314.349.1600  
F 314.349.1730  
CERTIFICATE OF AUTHORITY NO. 4002

NO.	DESCRIPTION	DATE
1	UPDATED FROM SITE SURVEY AND NETTING REVISIONS	C JORDAN 02-18-2022
2	ISSUED FOR SUBMITTAL	C JORDAN 02-04-2022

**SUBMITTALS / REVISIONS**

**PROJECT NO:**  
A10396  
**PROJECT:**  
MERCER ISLAND COUNTRY CLUB  
4 COURT TENNIS DOME

**SCALE:**  
AS NOTED



**DRAWING TITLE:**  
STRUCTURAL NOTES AND  
SECTIONALIZING INSTALLATION  
DETAILS

**SHEET:**  
**AS0.01**





(NORTH)

# ARIZON™

## BUILDING SYSTEMS

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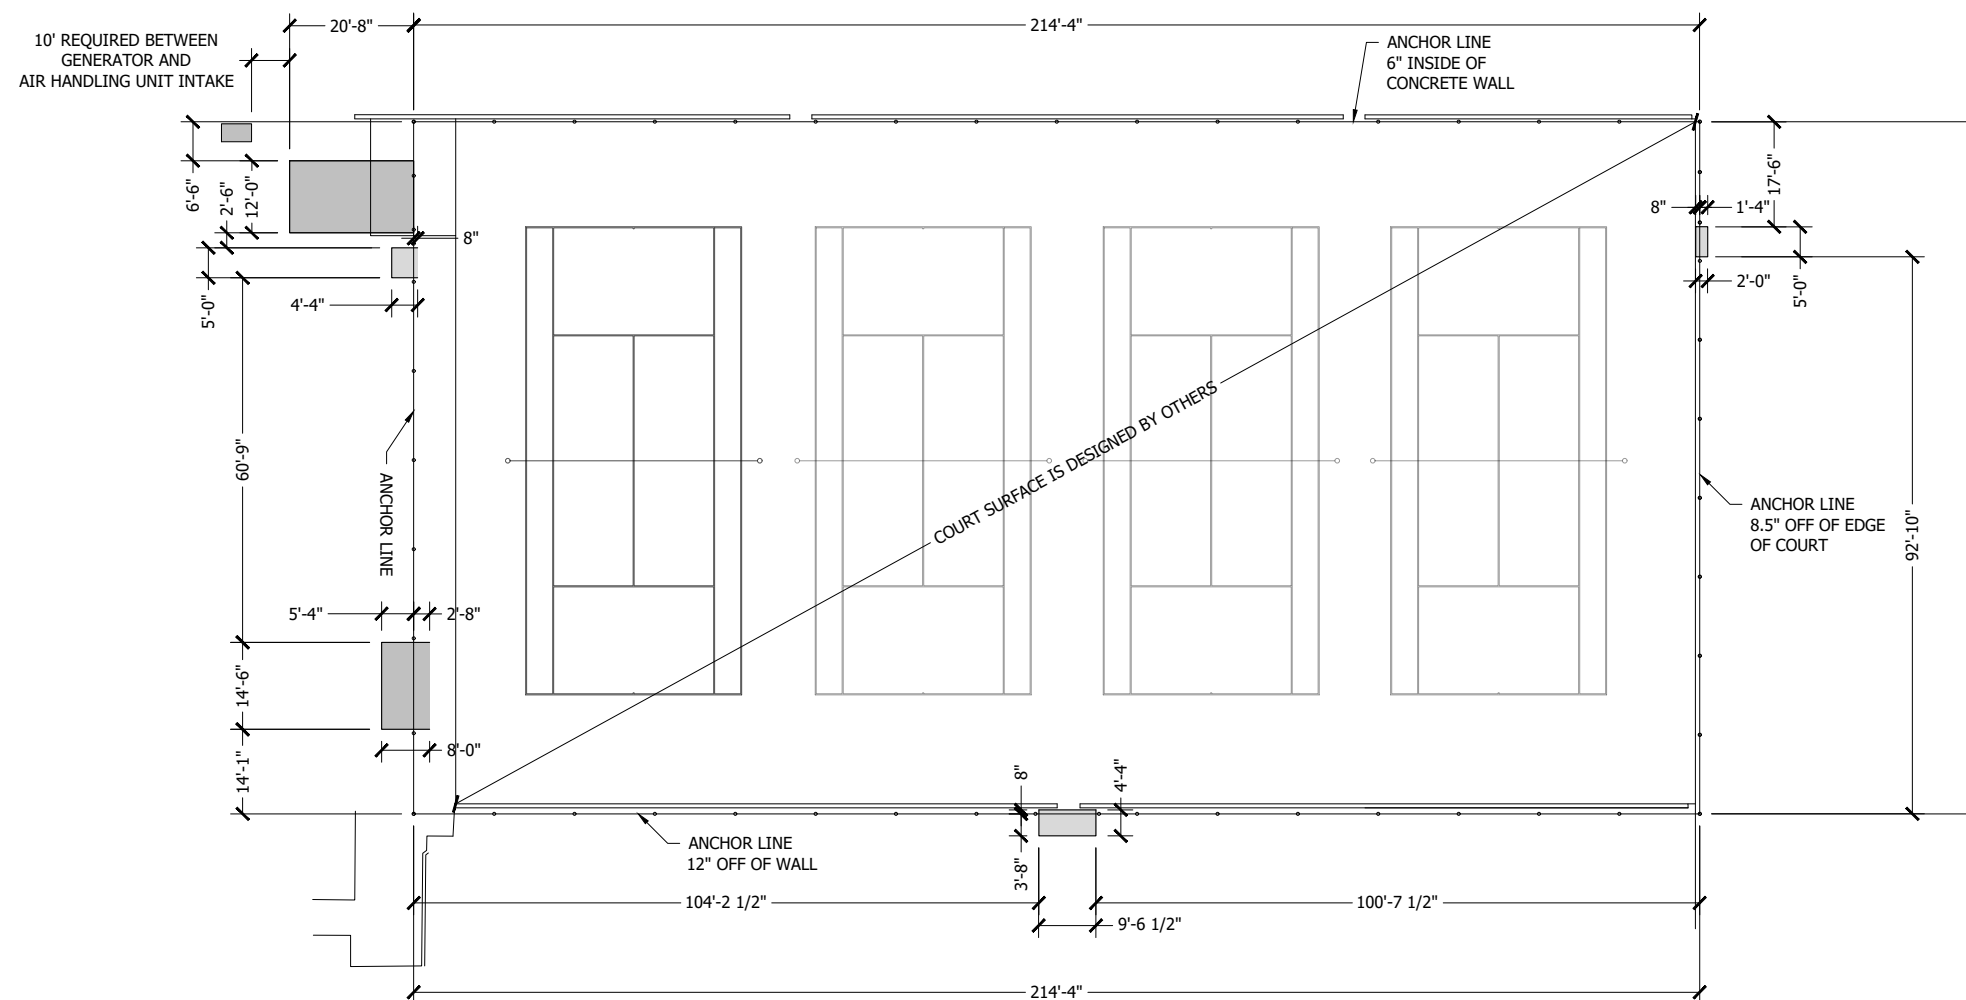
**ENGINEER:**

MISSOURI

### CASE

Engineering Inc.

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CERTIFICATE OF AUTHORITY NO. 4002



LEGEND

CONCRETE


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A10396

**PROJECT:**  
MERCER ISLAND COUNTRY CLUB  
4 COURT TENNIS DOME

**SCALE:**  
ANSI-B SIZE: 1/32"=1'-0"  
ANSI-D SIZE: 1/16"=1'-0"



**DRAWING TITLE:**  
FOUNDATION PLAN

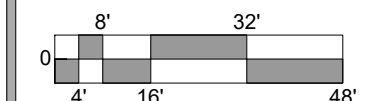**SHEET:**  
AS1.01

1 FOUNDATION PLAN  
SCALE: 1/16" = 1'-0"

**NOT FOR CONSTRUCTION**




**ARIZON**<sup>TM</sup>  
**BUILDING SYSTEMS**  
 11880 Dorset Rd.  
 St. Louis, MO, USA 63043  
 Tel: (314) 739-0037  
 www.arizonbuildingsystems.com

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 Mercer Island Country Club  
 Dan Nordale  
 8700 SE 71st Street  
 Mercer Island, WA 98040  
 Tel: (206) 295-3687

**JOB SITE ADDRESS:**  
 8700 SE 71st Street  
 Mercer Island, WA 98040



- GENERAL NOTES:**
1. DIMENSIONS ARE LOCATING THE HELICAL EARTH ANCHORS FOR ANCHORING THE AIR-SUPPORTED STRUCTURE. (SEE DETAIL 1/AS2.01)
  2. THE HELICAL EARTH ANCHORS ARE CENTERED ALONG THE ANCHOR LINE OF THE DOME.
  3. EACH ANCHOR LOCATION SHOULD HAVE A 12" DIAMETER (INSIDE DIAMETER) SLEEVED HOLE THROUGH CONCRETE SLAB FOR ANCHOR INSTALLATION.
  4. AFTER INSTALLATION OF THE DOME, THESE SLEEVED HOLES SHOULD BE CAPPED TO REDUCE WATER INFILTRATION. THE TOP SHACKLE/EYELET MUST BE VISIBLE AND ABLE TO ATTACHED TO.

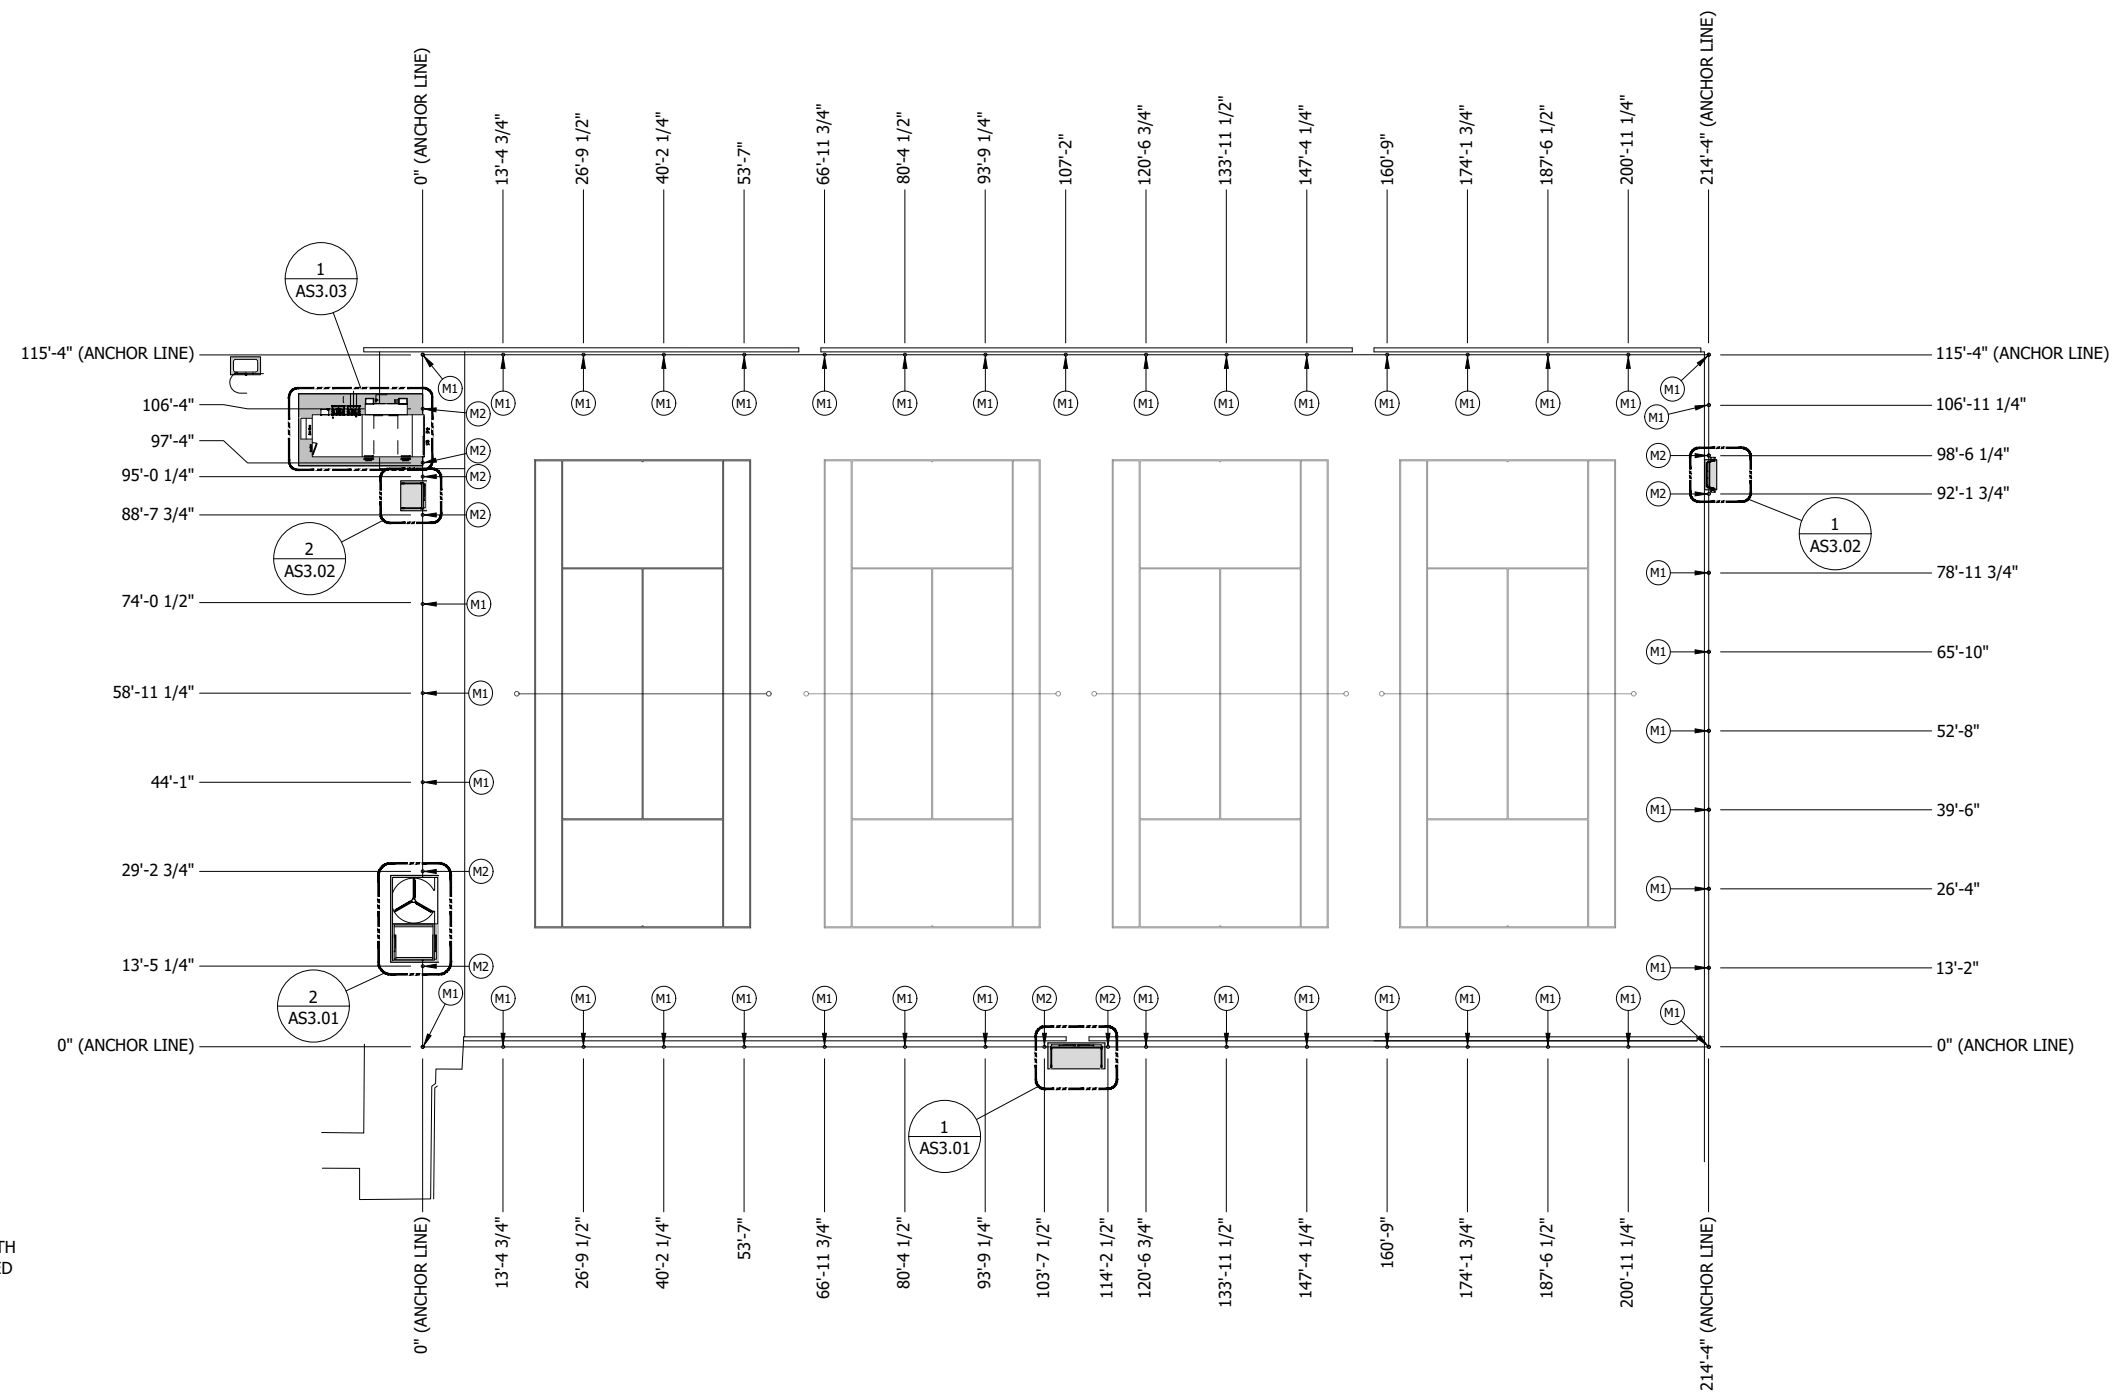EARTH ANCHOR LOADING CHART					
ANCHOR DESIGNATION	VERTICAL LOAD KIPS (ASD)	HORIZONTAL LOAD KIPS (ASD)	PITCH ANGLE OF INSTALLATION	COMPONENT	QUANTITY OF ANCHORS
M1	20 KIPS	10 KIPS	15° ± 5°	MAIN CATENARY SYSTEM	43
M2	25 KIPS	10 KIPS	15° ± 5°	OPENING + CATENARY SYSTEM	10

**LEGEND**

CONCRETE

	UPDATED FROM SITE SURVEY AND NETTING REVISIONS	C JORDAN 02-18-2022
	ISSUED FOR SUBMITTAL	C JORDAN 02-04-2022

**SUBMITTALS / REVISIONS**

**PROJECT NO:**  
A10396

**PROJECT:**  
MERCER ISLAND COUNTRY CLUB  
4 COURT TENNIS DOME

**SCALE:**  
 ANSI-B SIZE: 1/32"=1'-0"  
 ANSI-D SIZE: 1/16"=1'-0"

**DRAWING TITLE:**  
EARTH ANCHOR PLAN

**SHEET:**

**1 HELICAL EARTH ANCHOR PLAN**  
 SCALE: 1/16" = 1'-0"

**NOT FOR CONSTRUCTION**

**AS1.02**





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**JOB SITE ADDRESS:**  
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 Mercer Island, WA 98040

**ENGINEER:**


MISSOURI

**CASE**

**Engineering Inc.**

796 Menz Court  
 St. Louis, MO 63026  
 T 316.349.1600  
 F 316.349.1730

CERTIFICATE OF AUTHORITY NO. 4002

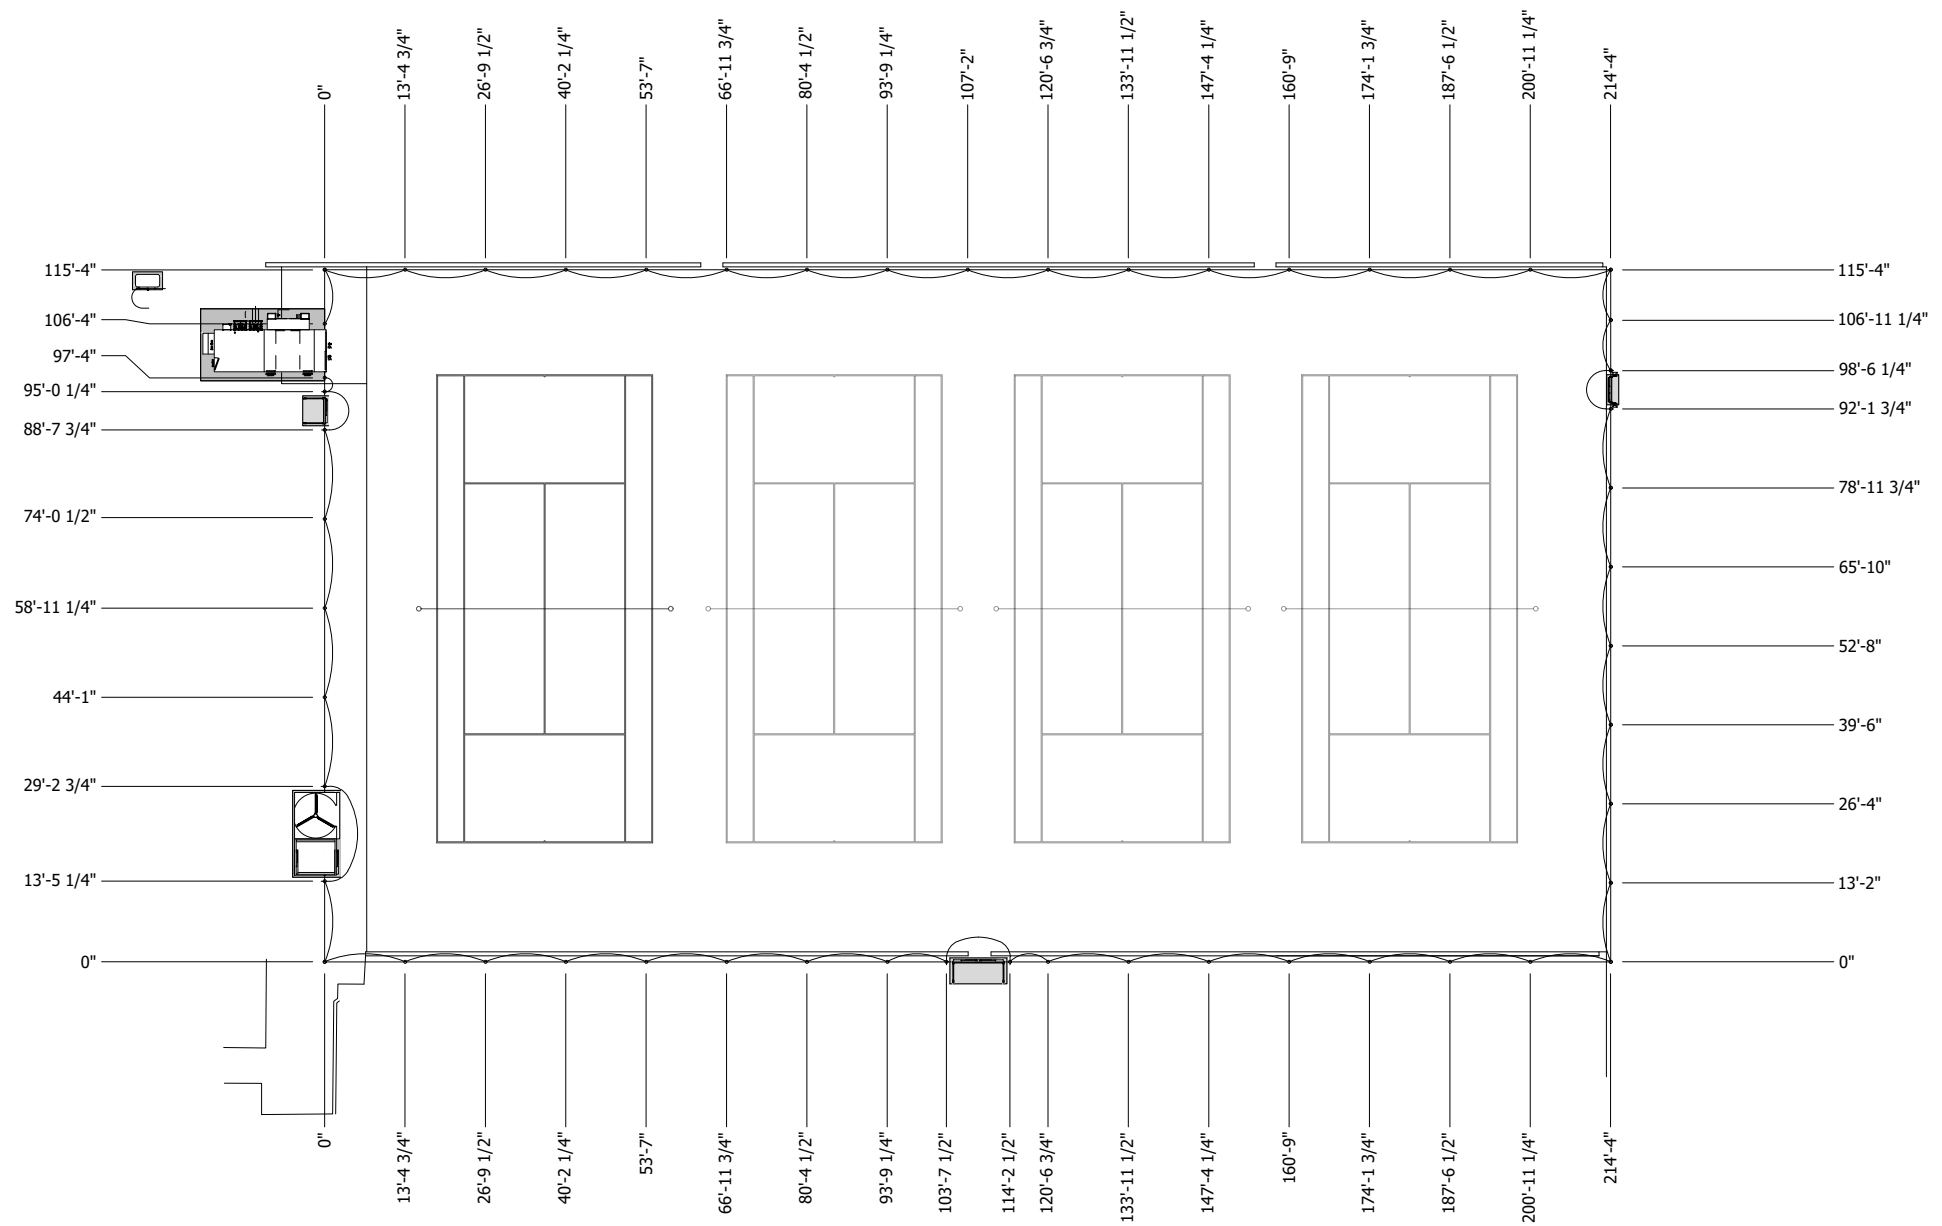

- LEGEND**
- CATENARY CABLE
  - CONCRETE

**GENERAL NOTES:**  
 1. DIMENSIONS SHOWN IS THE LOCATION WHERE THE CATENARY CABLE ATTACHES TO THE HELICAL EARTH ANCHOR.

1	UPDATED FROM SITE SURVEY AND NETTING REVISIONS	C JORDAN 02-18-2022
0	ISSUED FOR SUBMITTAL	C JORDAN 02-04-2022

**SUBMITTALS / REVISIONS**

**PROJECT NO:**  
 A10396

**PROJECT:**  
 MERCER ISLAND COUNTRY CLUB  
 4 COURT TENNIS DOME

**SCALE:**  
 ANSI-B SIZE: 1/32"=1'-0"  
 ANSI-D SIZE: 1/16"=1'-0"

**DRAWING TITLE:**  
 STRUCTURAL CABLES PLAN

**SHEET:**  
 AS1.03




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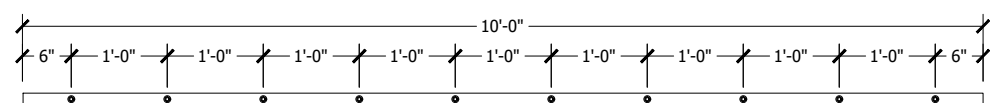
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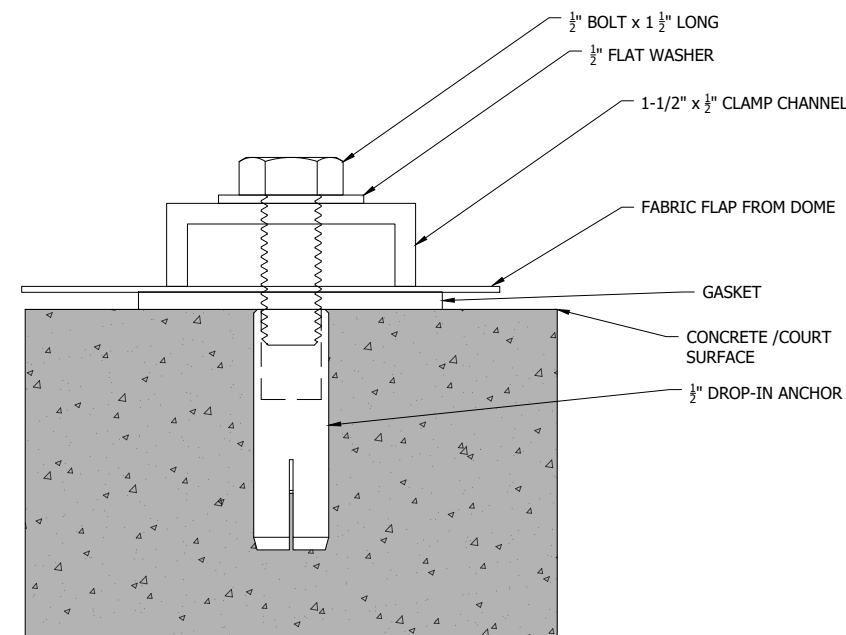


**3** ISOMETRIC VIEW OF CLAMP CHANNEL SYSTEM  
 SCALE: 1" = 1'-0"



NOTE: ARIZON WILL SUPPLY 10' SECTIONS OF CLAMP CHANNEL THAT MAY NEED TO BE CUT TO LENGTH IN THE FIELD DURING THE INITIAL INSTALLATION.

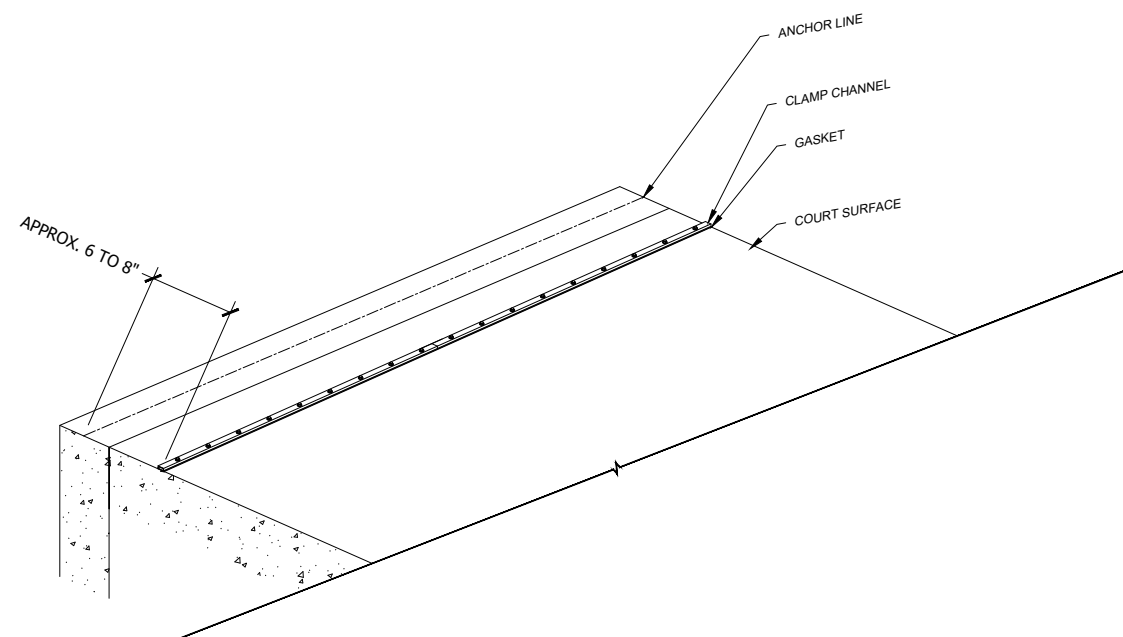**2** TYPICAL PLAN VIEW OF CLAMP CHANNEL  
 SCALE: 1" = 1'-0"




**1** ENLARGED VIEW OF CLAMP CHANNEL SYSTEM  
 SCALE: 1" = 1'-0"

⚠	UPDATED FROM SITE SURVEY AND NETTING REVISIONS	C JORDAN 02-18-2022
⚠	ISSUED FOR SUBMITTAL	C JORDAN 02-04-2022

**SUBMITTALS / REVISIONS**

**PROJECT NO:**  
 A10396  
**PROJECT:**  
 MERCER ISLAND COUNTRY CLUB  
 4 COURT TENNIS DOME

**SCALE:**  
 ANSI-B SIZE: 1/2"=1'-0"  
 ANSI-D SIZE: 1"=1'-0"

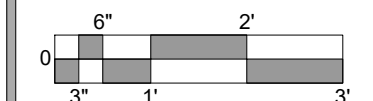

**DRAWING TITLE:**  
 CONC CONSTRUCTION,  
 EXPANSION, AND CONTROL  
 JOINTS, CORNER DETAILS



**SHEET:**  
 AS2.02

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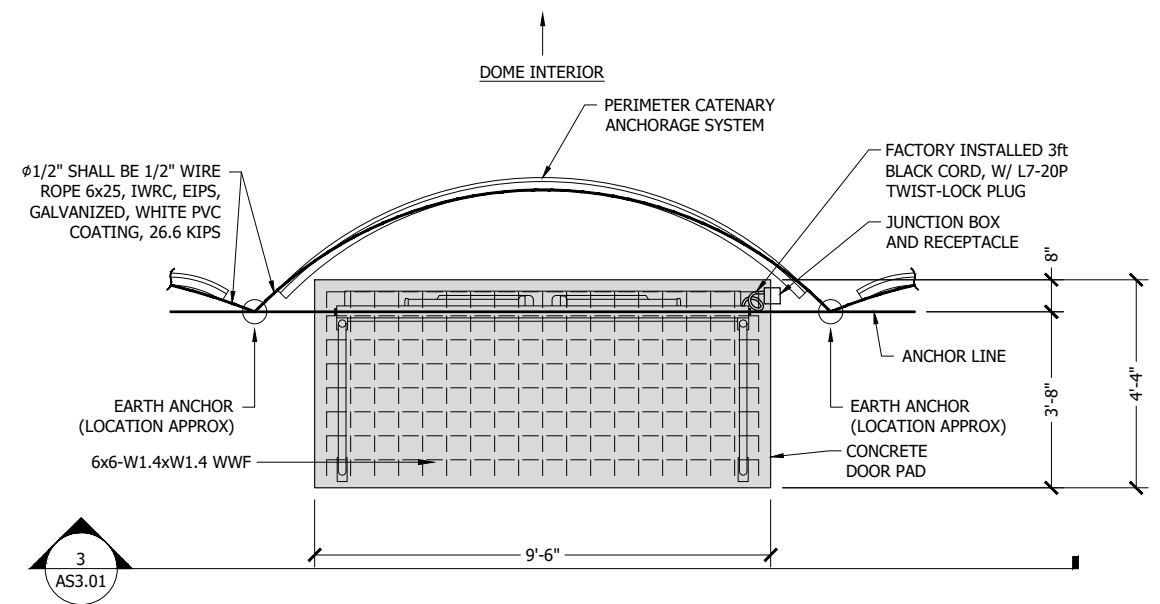
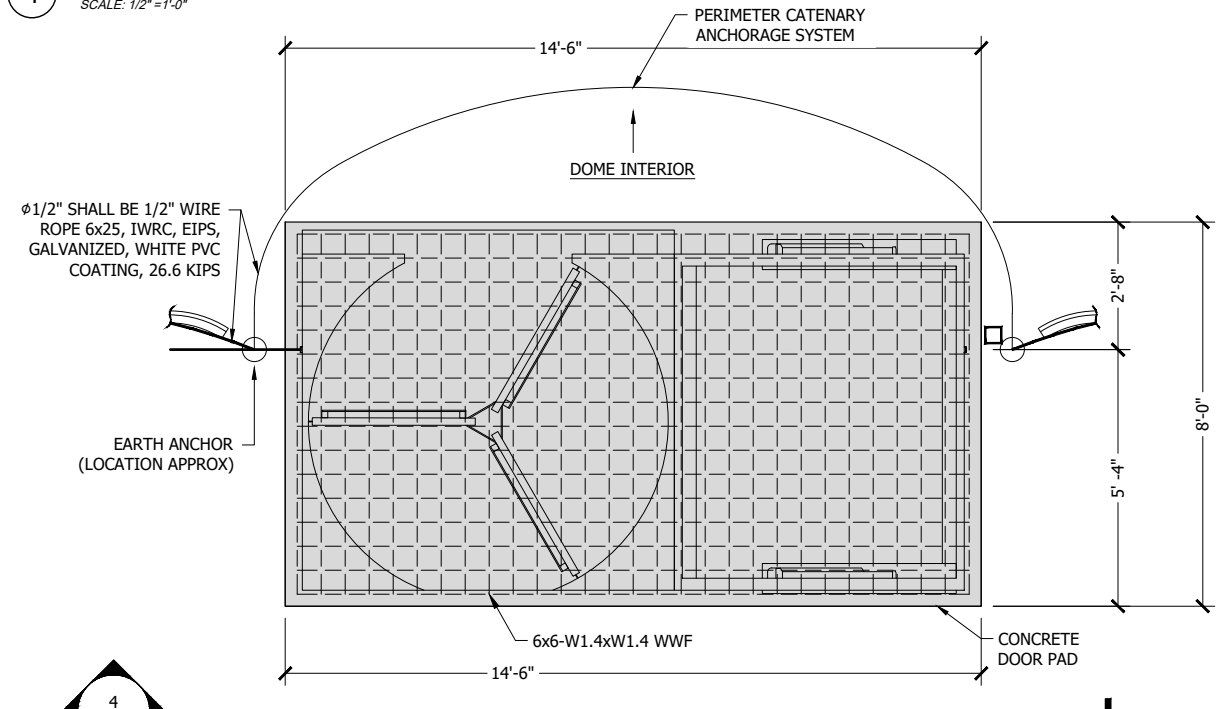
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 Tel: (206) 295-3687

**JOB SITE ADDRESS:**  
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 Mercer Island, WA 98040



4 ENLARGED ELEVATION AT COMBO DOOR  
 SCALE: 1/2" = 1'-0"

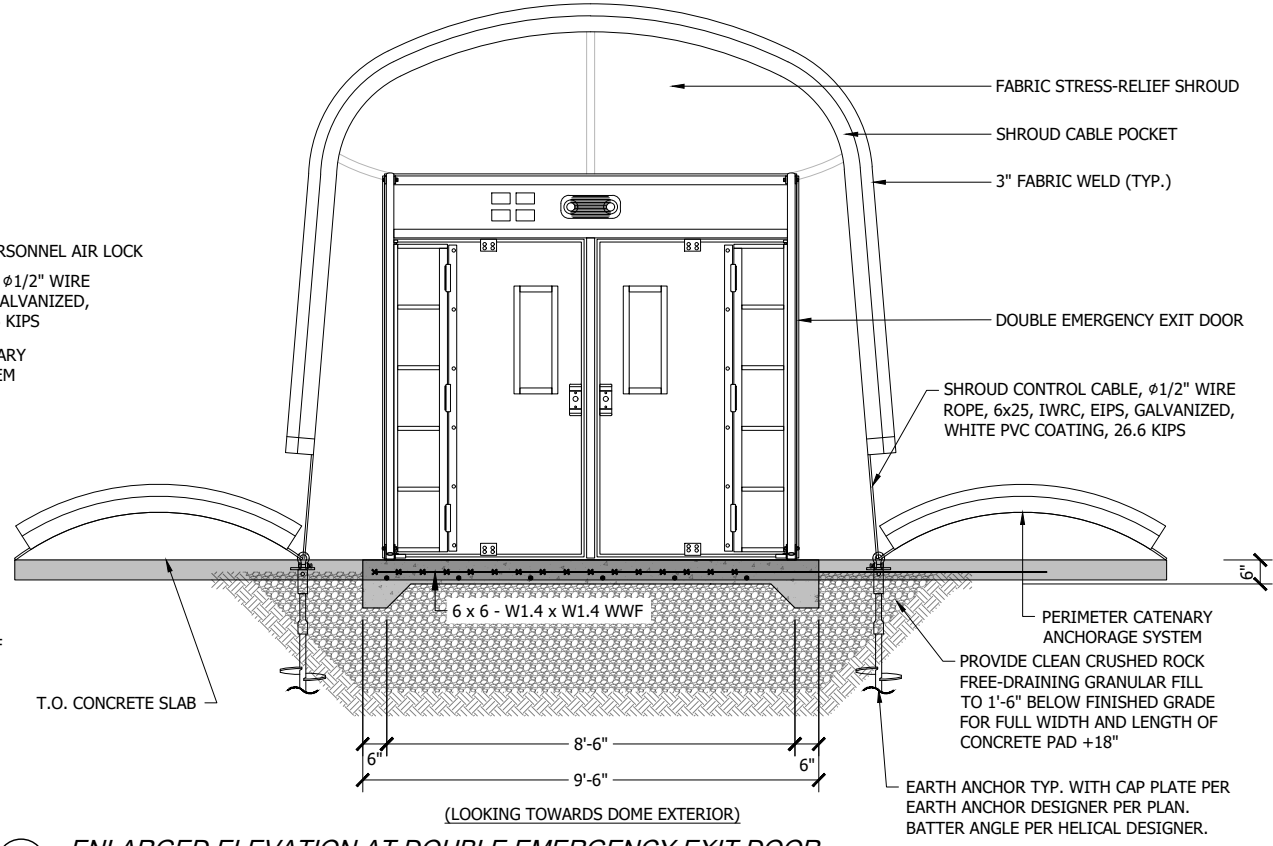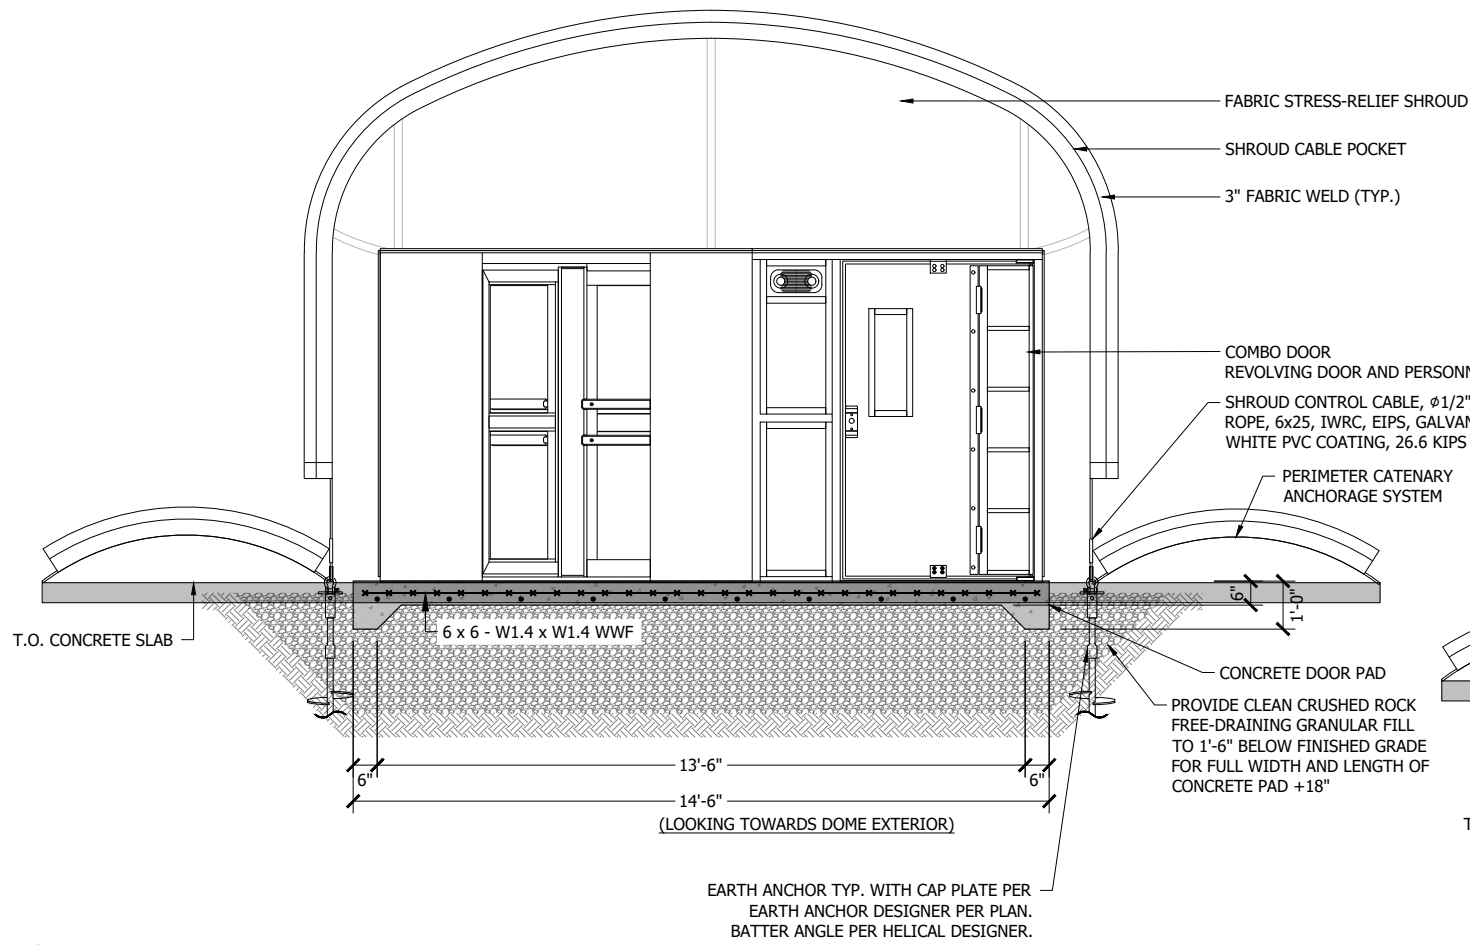3 ENLARGED ELEVATION AT DOUBLE EMERGENCY EXIT DOOR  
 SCALE: 1/2" = 1'-0"



2 ENLARGED SHROUD ANCHOR PLAN AT COMBO DOOR  
 SCALE: 1/2" = 1'-0"


1 ENLARGED SHROUD ANCHOR PLAN AT DOUBLE EMERGENCY EXIT DOOR  
 SCALE: 1/2" = 1'-0"

1	UPDATED FROM SITE SURVEY AND NETTING REVISIONS	C JORDAN
		02-18-2022
2	ISSUED FOR SUBMITTAL	C JORDAN
		02-04-2022

**SUBMITTALS / REVISIONS**

**PROJECT NO:**  
 A10396  
**PROJECT:**  
 MERCER ISLAND COUNTRY CLUB  
 4 COURT TENNIS DOME

**SCALE:**  
 AS NOTED

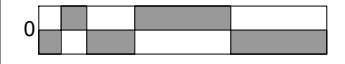

**DRAWING TITLE:**  
 ENLARGED ANCHORAGE DETAILS AT MAIN COMBO AND DOUBLE EXIT DOOR SHROUDS

**SHEET:**  
 AS3.01









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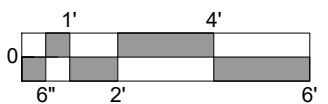


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		02-18-2022
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**SUBMITTALS / REVISIONS**

**PROJECT NO:**  
 A10396  
**PROJECT:**  
 MERCER ISLAND COUNTRY CLUB  
 4 COURT TENNIS DOME

**SCALE:**  
 ANSI-B SIZE: 1/4" = 1'-0"  
 ANSI-D SIZE: 1/2" = 1'-0"

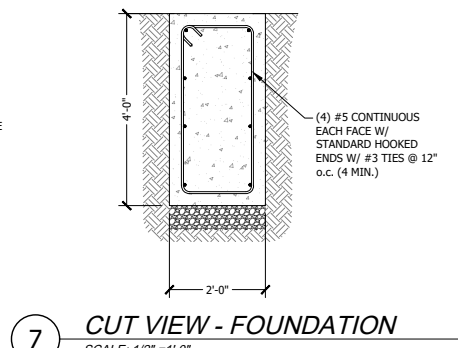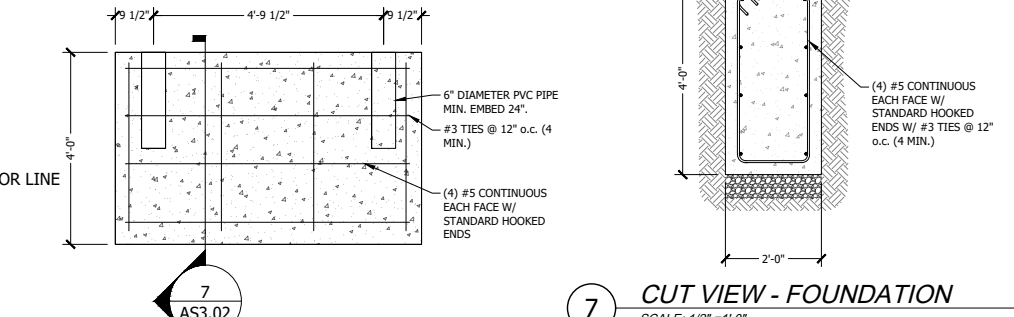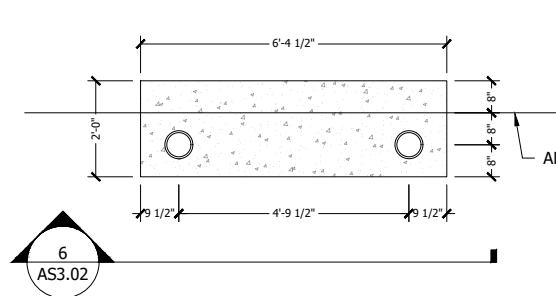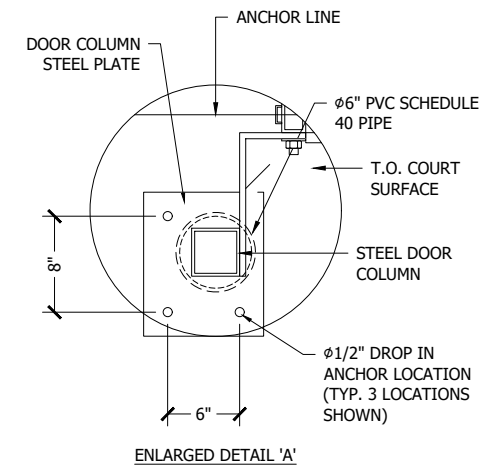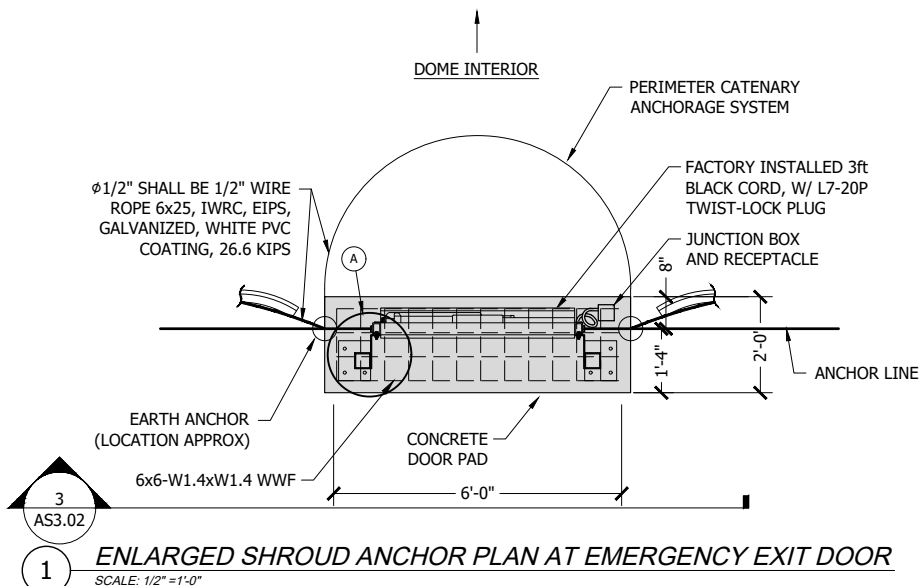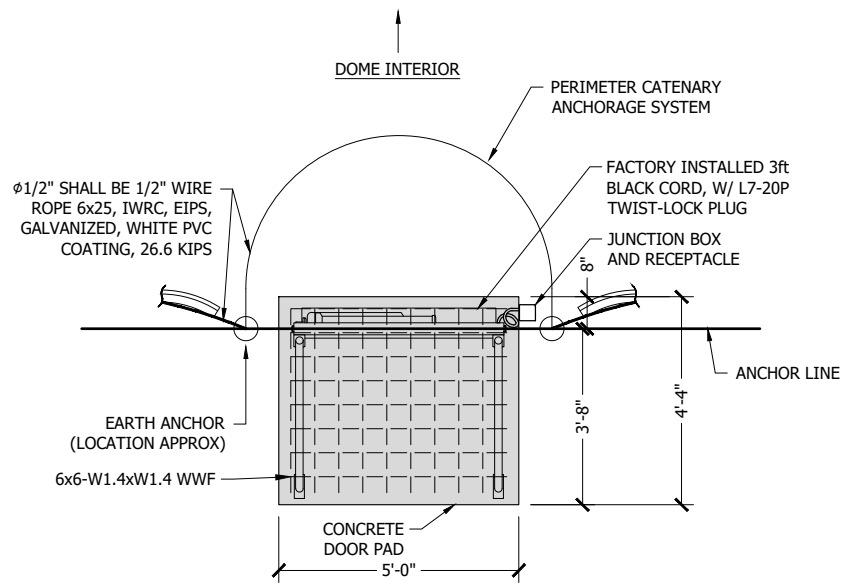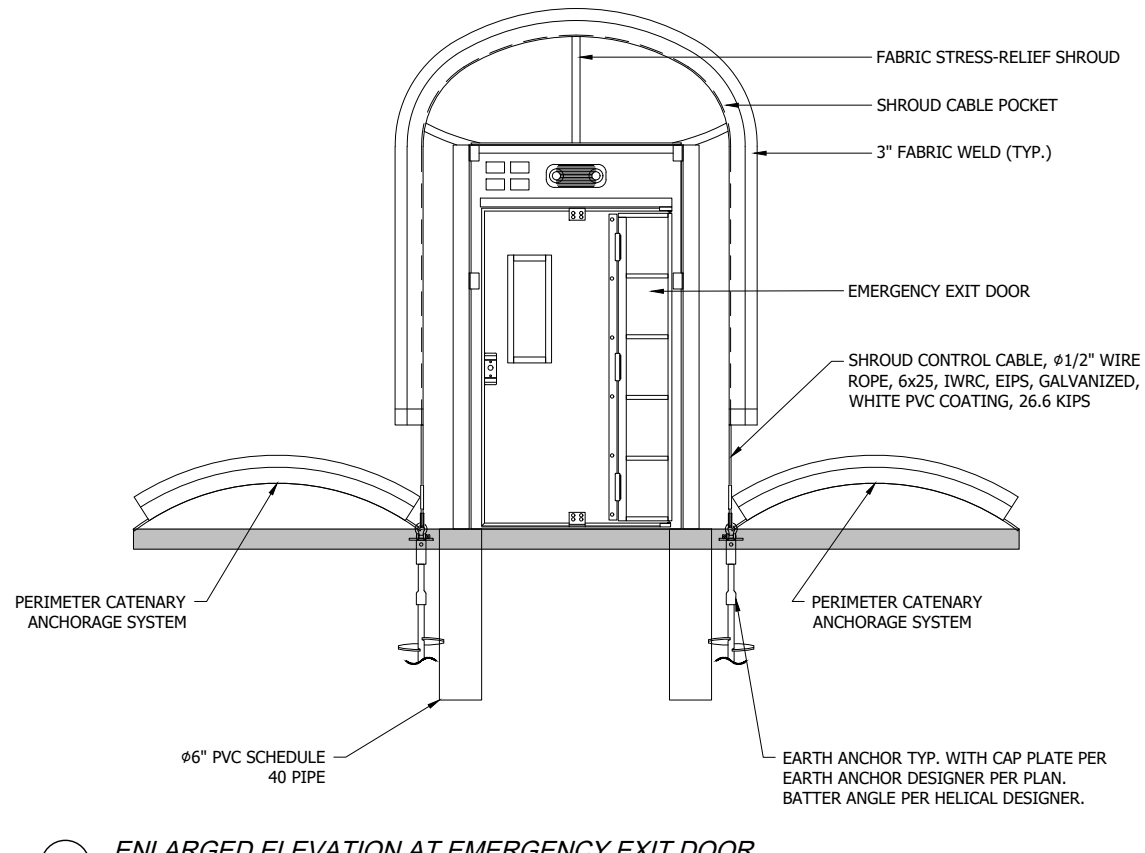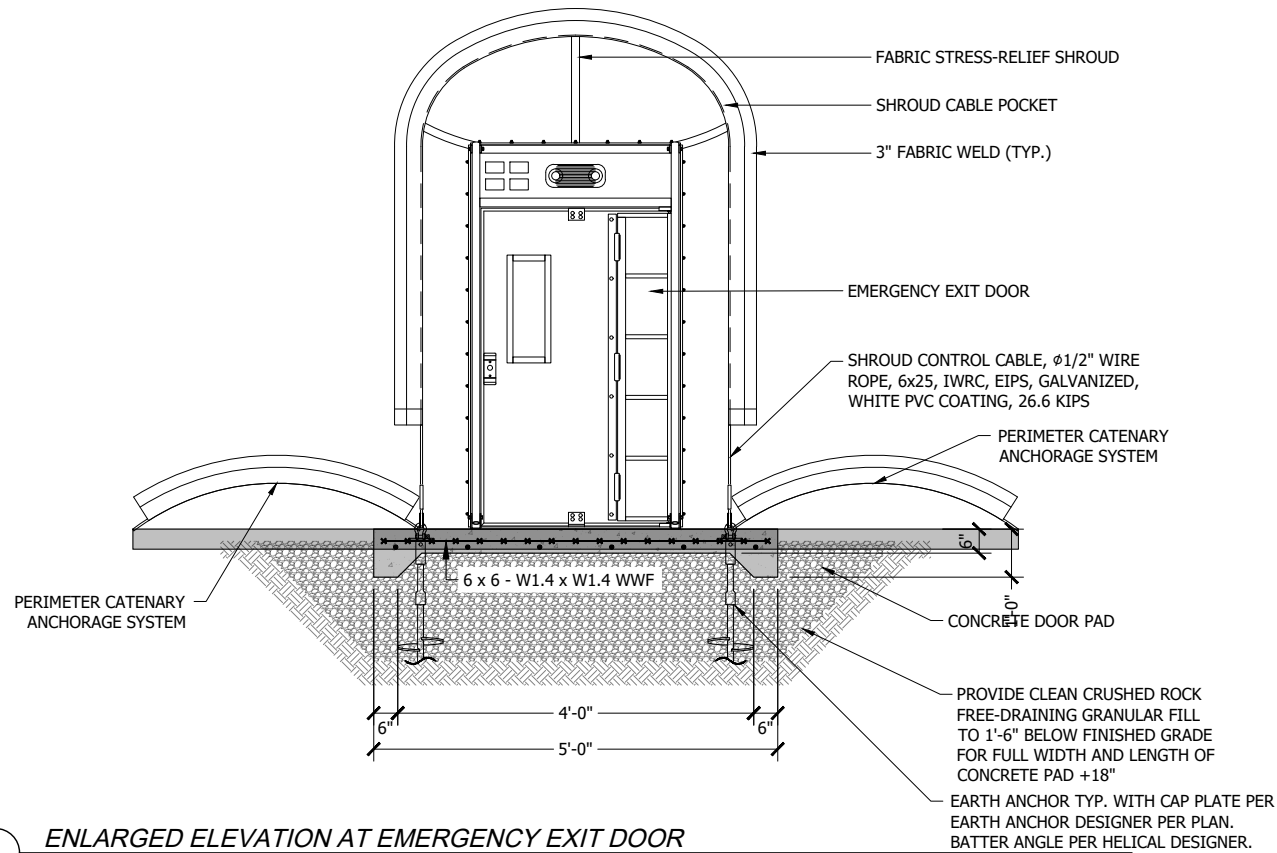

**DRAWING TITLE:**  
 ENLARGED ANCHORAGE DETAILS AT EXIT DOOR SHROUDS

**SHEET:**  
 AS3.02

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**ENGINEER:**


MISSOURI  
**CASE**  
 Engineering Inc.  
 796 Merens Court  
 St. Louis, MO 63026  
 T 316.349.1600  
 F 316.349.1730  
 CERTIFICATE OF AUTHORITY NO. 4002

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⚠	ISSUED FOR SUBMITTAL	C JORDAN 02-04-2022

**SUBMITTALS / REVISIONS**


**PROJECT NO:**  
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 4 COURT TENNIS DOME

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 ANSI-D SIZE: 1/2"=1'-0"

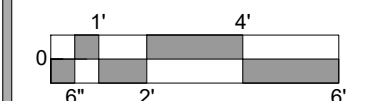


**DRAWING TITLE:**  
 ENLARGED ANCHORAGE DETAILS  
 AT AIR HANDLING UNIT SHROUDS


**SHEET:**  
 AS3.03

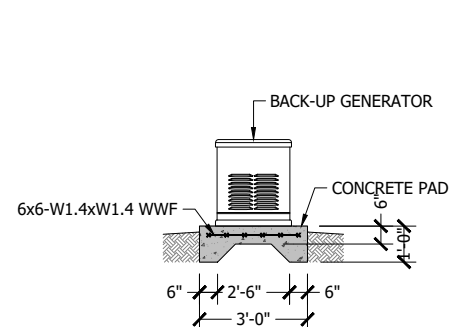


**4 ENLARGED ELEVATION AT GENERATOR**  
 SCALE: 1/2" = 1'-0"

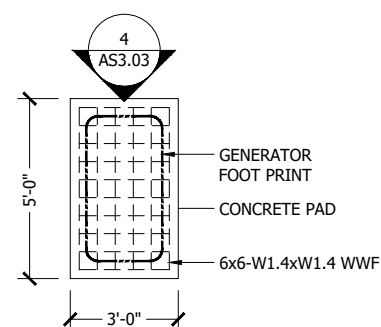

**3 ENLARGED PLAN AT GENERATOR**  
 SCALE: 1/2" = 1'-0"

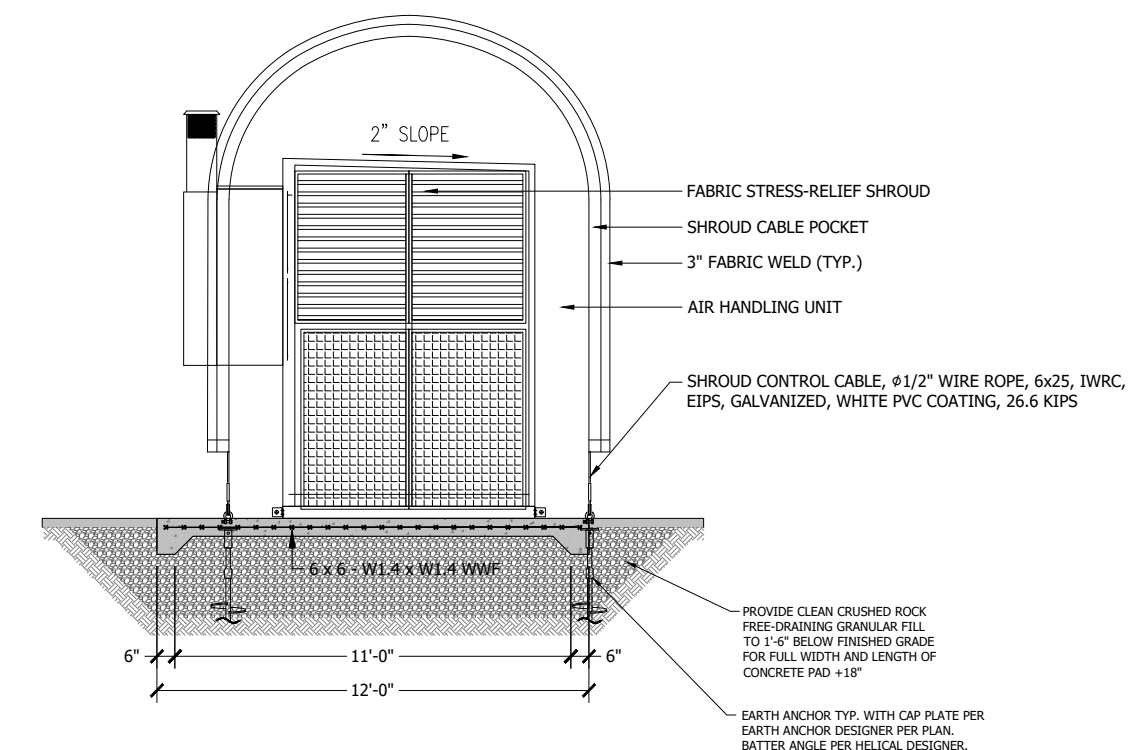

**2 ELEVATION VIEW SHROUD ANCHOR PLAN AT AIR HANDLING UNIT**  
 SCALE: 1/2" = 1'-0"

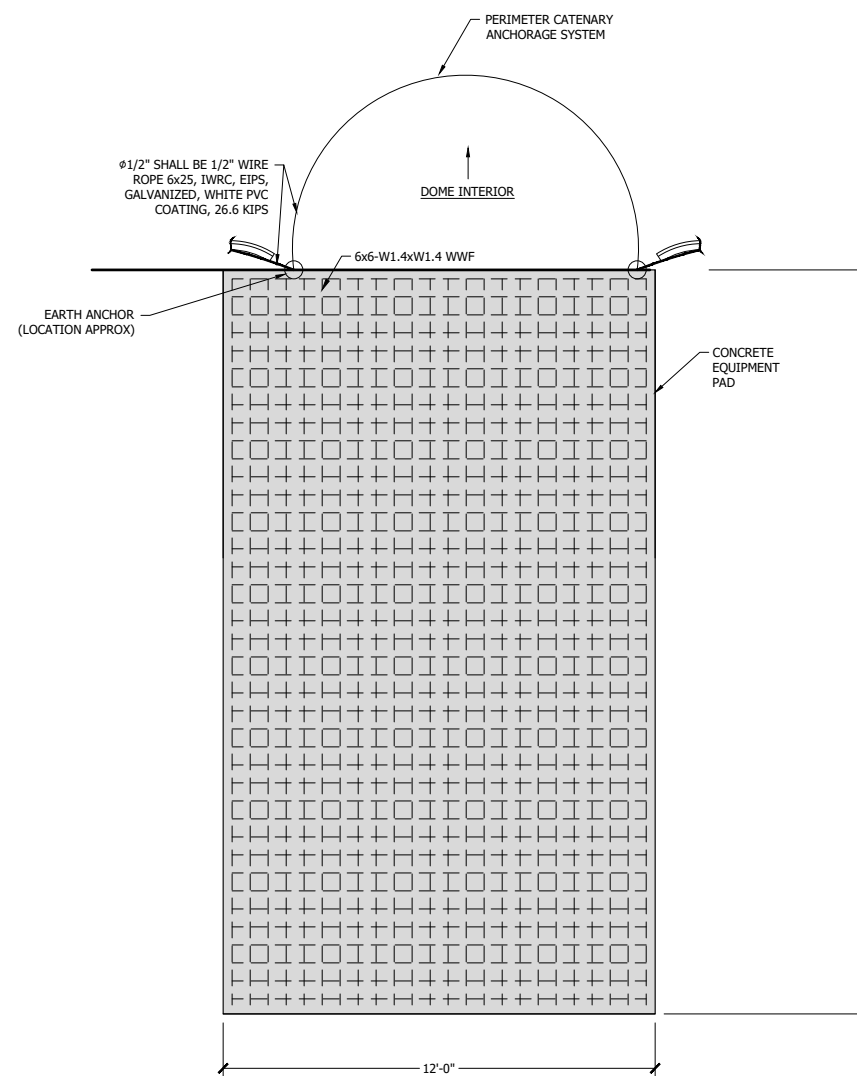

**1 ENLARGED SHROUD ANCHOR PLAN AT AIR HANDLING UNIT**  
 SCALE: 1/2" = 1'-0"

**NOT FOR CONSTRUCTION**

# MERCER ISLAND COUNTRY CLUB

## TENNIS COURT IMPROVEMENT

### CIVIL PLANS

#### LEGEND

##### STORM LEGEND

	STORM PIPE
	STORM STRUCTURE
	STORM SERVICE
	STORM PIPE FLOW ARROW
	STORM POND BOTTOM
	STORM POND TOP
	STORM POND WATER LEVEL
	STORM VAULT EXTERIOR WALL
	STORM VAULT INTERIOR WALL
	STORM VAULT WATER LEVEL
	STORM EASEMENT
	STORM BIO SWALES
	STORM BIO SWALES PATTERN
	STORM TEXT
	EXISTING STORM PIPE
	EXISTING STORM PROFILE
	EXISTING STORM TEXT
	RIPRAP

##### ROAD LEGEND

	CURB LINES
	GUTTER LINES
	ASPHALT ROAD
	ASPHALT ROAD PATTERN
	SIDEWALK
	SIDEWALK PATTERN
	DRIVEWAY
	DRIVEWAY PATTERN
	GRAVEL
	GRAVEL PATTERN
	HANDICAP RAMP
	HANDICAP RAMP PATTERN
	ROAD MARKINGS
	SAWCUT
	OVERLAY
	ROAD EASEMENT

##### SEWER LEGEND

	SEWER PIPE
	SEWER STRUCTURE
	SEWER SERVICE
	SEWER PIPE FLOW ARROW
	SEWER EASEMENT
	EXISTING SEWER PIPE
	EXISTING SEWER PIPE PROFILE
	EXISTING SEWER TEXT

##### SITE LEGEND

	TRAIL LINES
	TRAIL PATTERN
	PATH LINES
	PATH PATTERN
	SITE CONCRETE LINES
	SITE CONCRETE PATTERN
	SITE ROCK WALL
	SITE BLOCK WALL
	WOOD FENCE
	METAL FENCE
	WETLAND
	WETLAND BUFFER
	STEEP SLOPE
	STEEP SLOPE BUFFER
	STREET LIGHT
	MAIL BOX
	SIGNS

##### WATER LEGEND

	WATER MAIN
	WATER FITTING
	FIRE HYDRANT
	WATER METER
	FIRE DEPARTMENT CONNECTION
	POST VALVE INDICATOR
	WATER EASEMENT
	EXISTING WATER PIPE
	EXISTING WATER PROFILE
	EXISTING WATER TEXT

##### SURFACE LEGEND

	EXISTING GROUND SURFACE TEXT
	EXISTING GROUND CONTOUR MINR
	FINISH GRADE SURFACE TEXT
	FINISH GRADE CONTOUR MAJR
	FINISH GRADE CONTOUR MINR
	FINISH GRADE DAYLIGHT

##### EROSION LEGEND

	CONSTRUCTION ENTRANCE GRAVEL
	CLEARING LIMITS LINE
	TEMPORARY PIPE
	SILT FENCE
	TREE RETENTION FENCE
	SWALES
	CONSTRUCTION FENCE
	ROCK CHECK DAM
	INLET PROTECTION
	RIP RAP
	STAND PIPE
	SLOPE DAGGER

##### VERTICAL DATUM

NAVD 88  
**BENCHMARK**


SW UPPER HYDRANT FLANGE BOLT ON HYDRANT AT THE NW CORNER OF THIS PARCEL  
ELEVATION: 512.69

##### BASIS OF BEARING

CITY OF BELLEVUE #218  
CASED MONUMENT INTERSECTION NE. 60TH STREET AND 130TH AVENUE NE  
ELEVATION: 490.48

##### LEGAL DESCRIPTION

LOT 9, SILVER SPURS RANCH, NO.2, ACCORDING TO THE PLAT THEREOF RECORDED IN VOLUME 69 OF PLATS, PAGE 88, IN KING COUNTY, WASHINGTON:  
TOGETHER WITH THAT PORTION OF VACATED 126TH AVENUE NORTHEAST WHICH ATTACHED BY OPERATOIN OF LAW

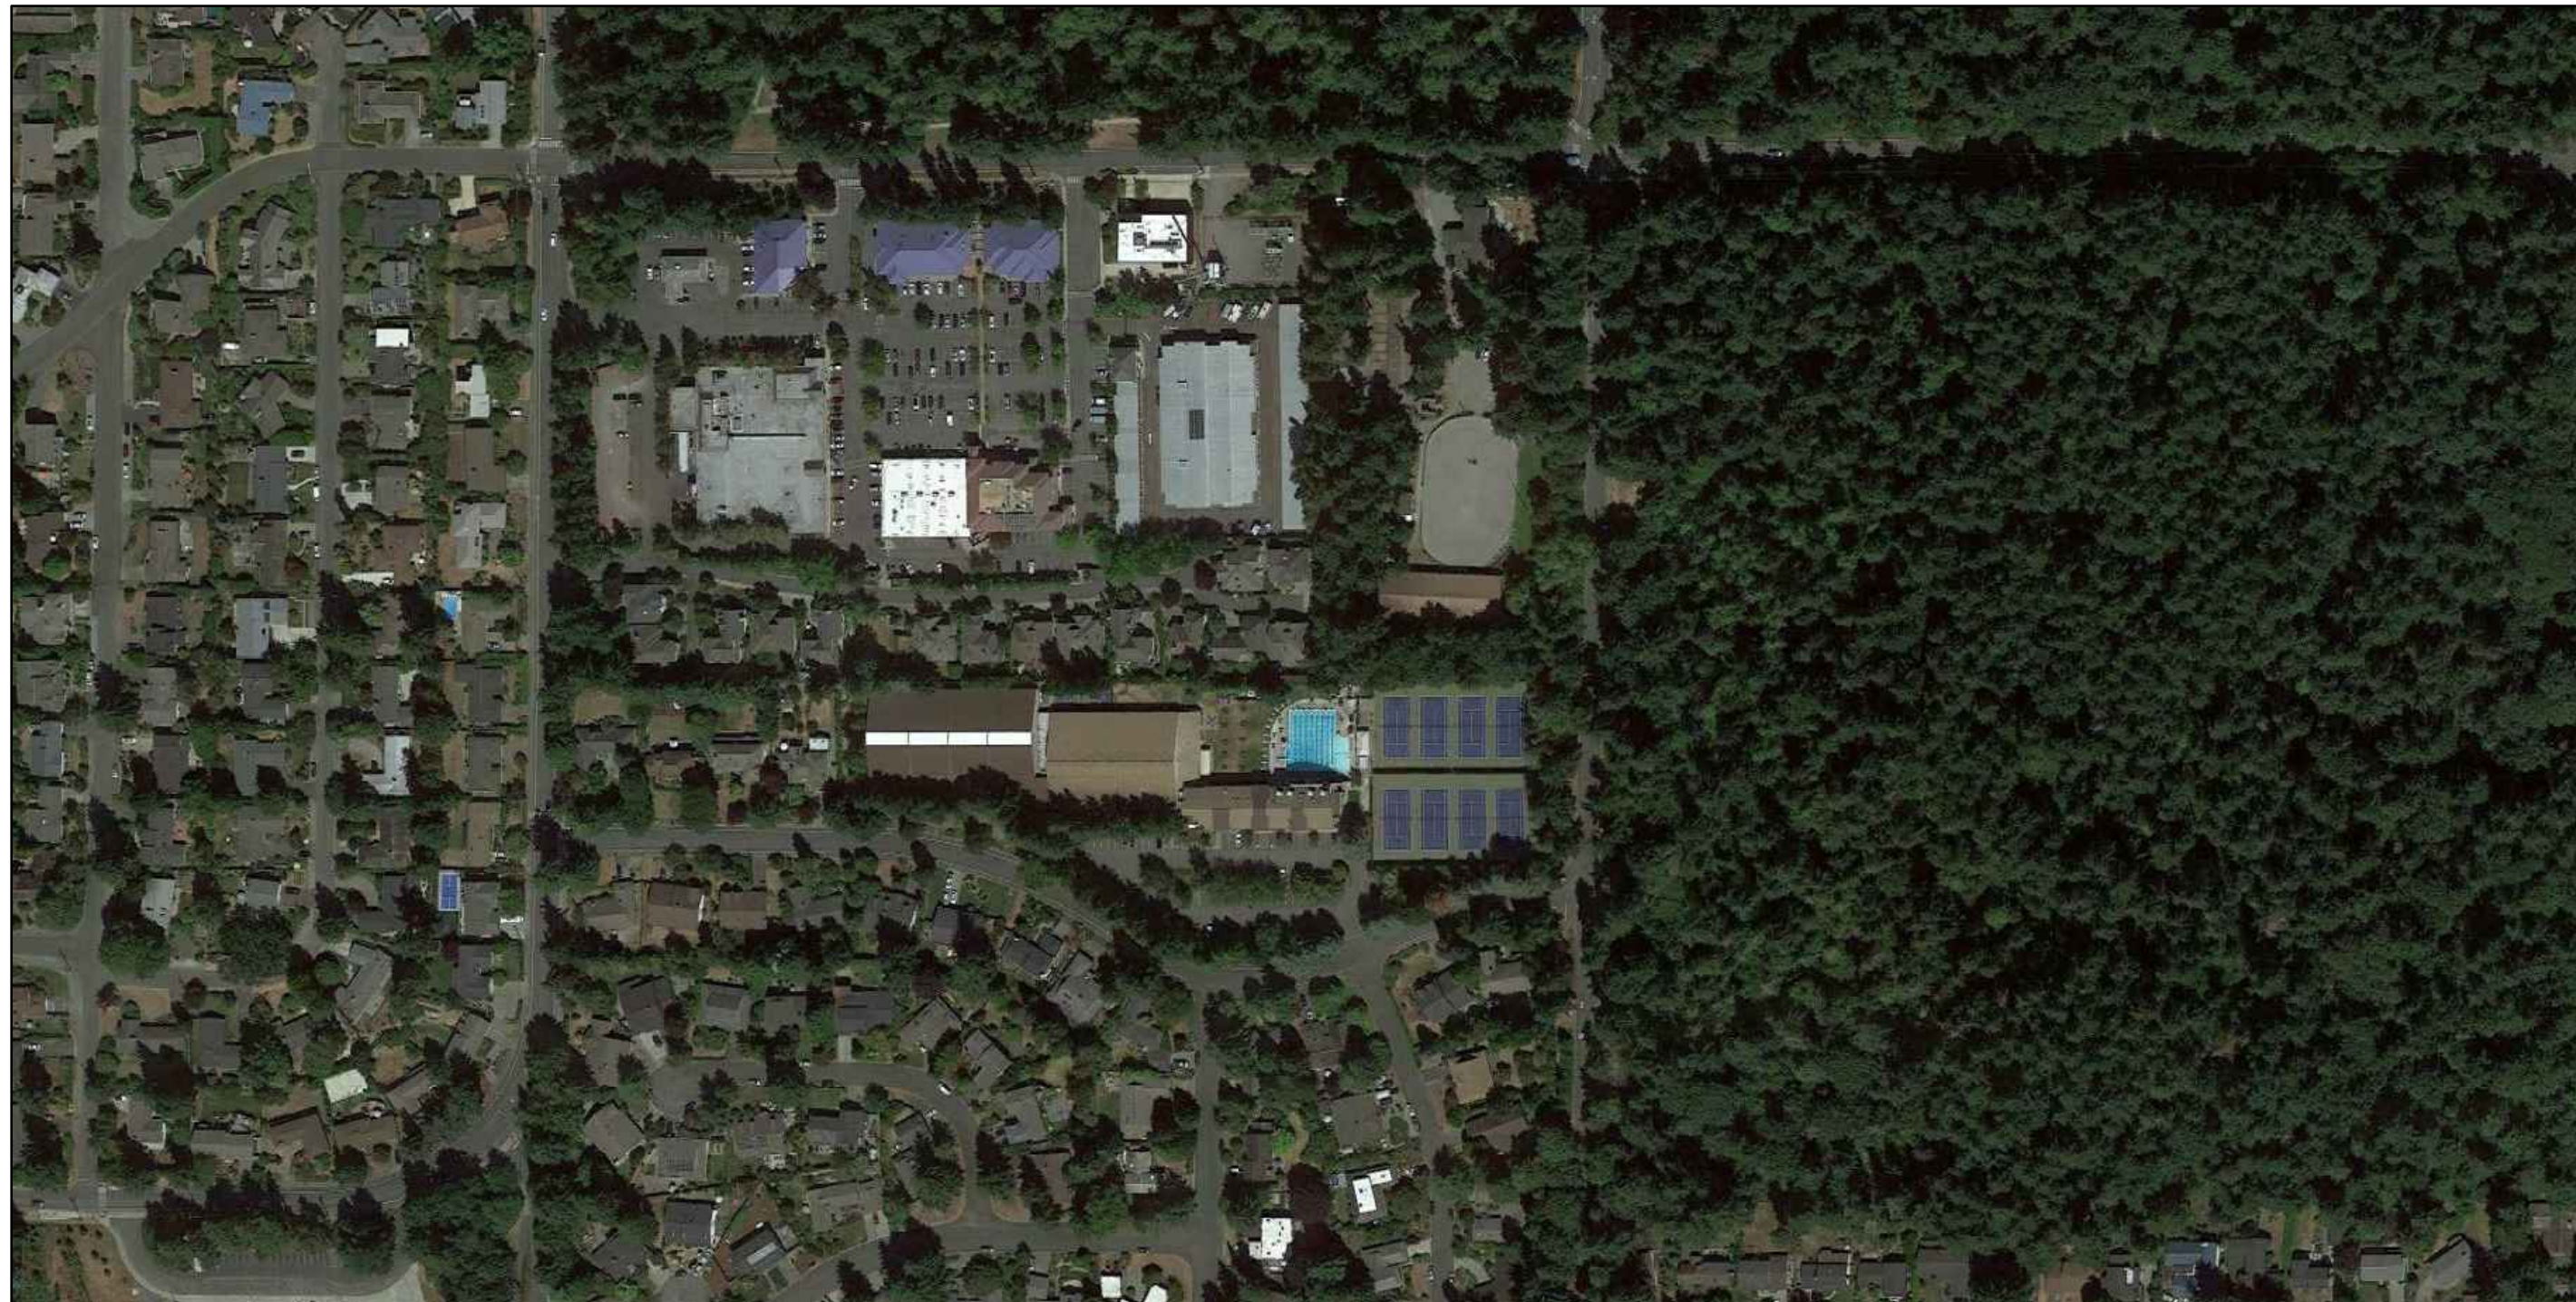

**SITE**  
NTS

##### IMPERVIOUS COVERAGE

EXISTING SITE HAS OVER 35% IMPERVIOUS COVERAGE

NEW IMPERVIOUS SURFACE:	40 SF
REPLACED IMPERVIOUS SURFACE:	1,408 SF
<b>TOTAL</b>	<b>1,448 SF NEW+REPLACED IMPERVIOUS</b>

##### SHEET INDEX

<b>CIVIL PLANS</b>	
1	COVER SHEET
2	EXISTING CONDITIONS, DEMOLITION, AND FOUNDATION
3	COURT TENNIS DOME LAYOUT
4	STORM DRAIN LAYOUT
5	DETAILS

##### OWNER/APPLICANT

MERCER ISLAND COUNTRY CLUB  
8700 SE 71ST ST  
MERCER ISLAND, WA 98040  
CONTACT: DAN NORDALE  
PH: (206) 395-3687

##### CIVIL ENGINEER/SURVEYOR

CORE DESIGN, INC  
14711 NE 29TH PLACE, SUITE 101  
BELLEVUE, WASHINGTON 98007  
CONTACT: MICHAEL A. WOODY, P.E. (ENGINEER)  
GLENN R. SPRAGUE, P.L.S. (SURVEYOR)  
PH: (425) 885-7877

##### ARCHITECT

ARIZON BUILDING SYSTEMS  
11880 DORSETT RD  
ST LOUIS, MO, 63043

DATE	
REVISIONS	
NO.	


12100 NE 195th St, Suite 300  
Bellevue, Washington 98011  
425.885.7877 Fax 425.885.7963



**COVER**  
**MERCER ISLAND CC**  
8700 SE 71ST STREET  
MERCER ISLAND, WA 98040


DATE	SEE STAMP DATE
DESIGNED	FLAHO BIANOTTI
DRAWN	MATT BISHOP
APPROVED	
	PROJECT MANAGER

SHEET	OF
1	5
PROJECT NUMBER	
20033	

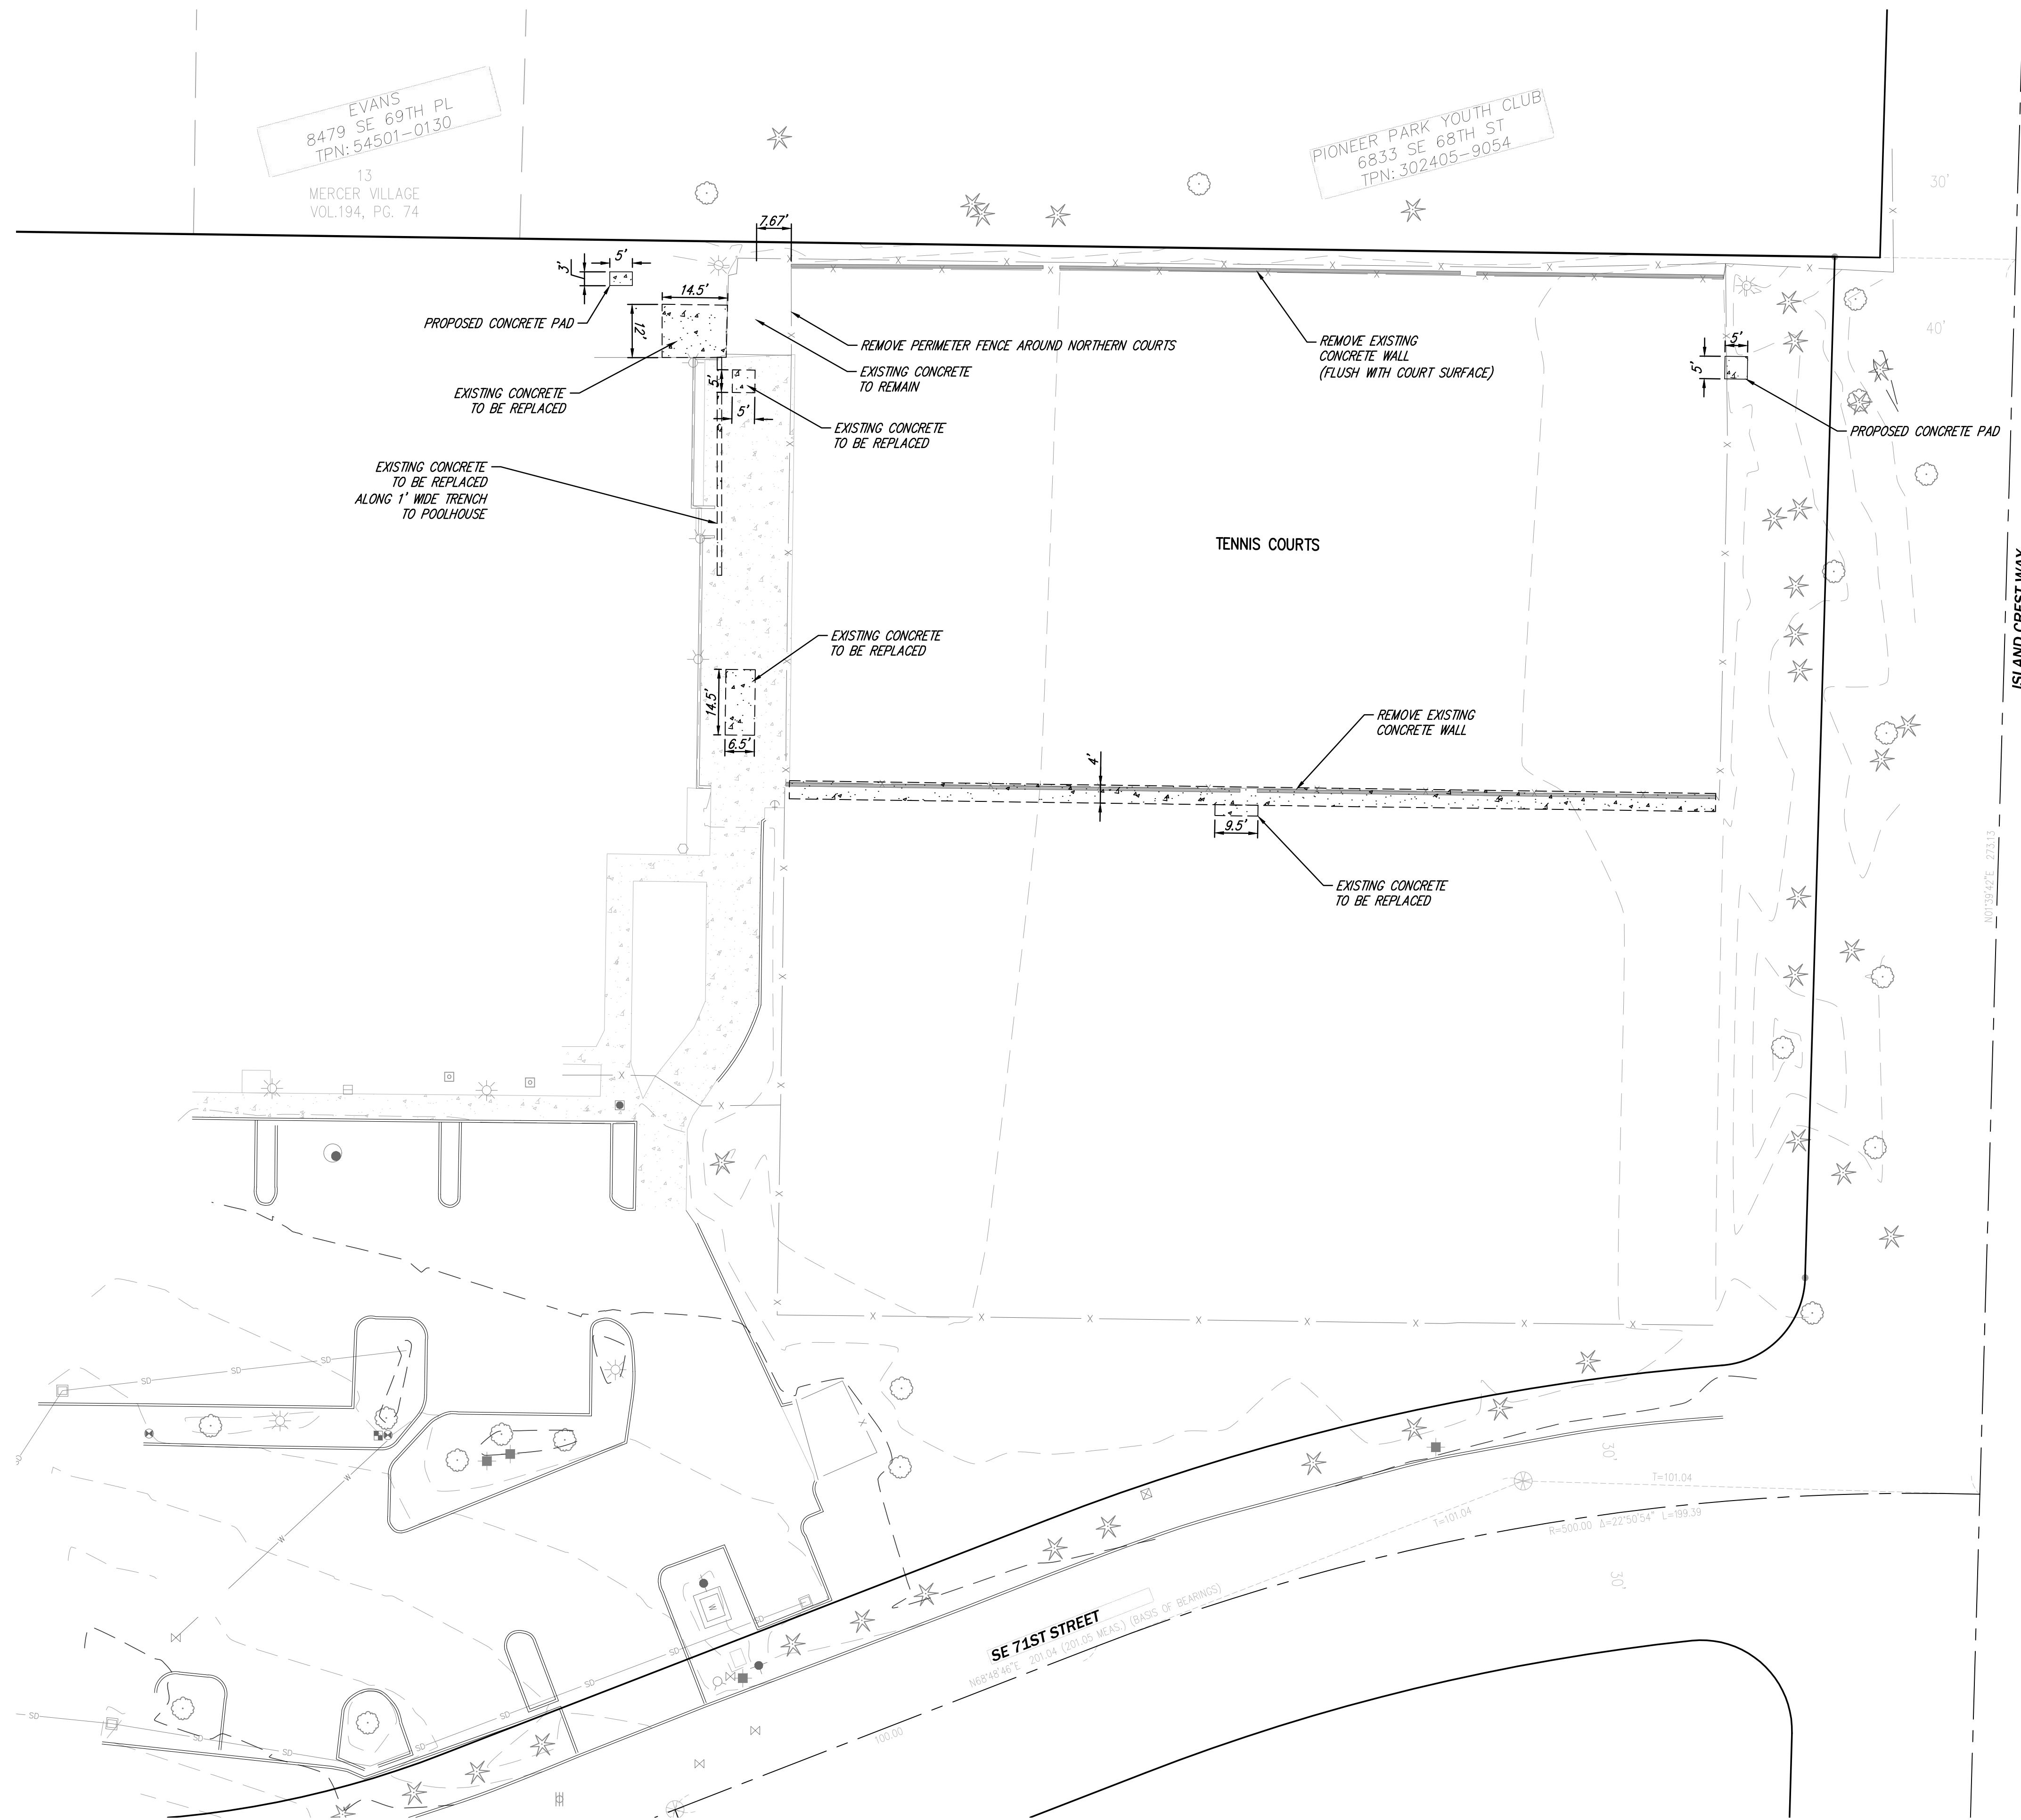

EVANS  
8479 SE 69TH PL  
TPN: 54501-0130  
13  
MERCER VILLAGE  
VOL.194, PG. 74

PIONEER PARK YOUTH CLUB  
6833 SE 68TH ST  
TPN: 302405-9054

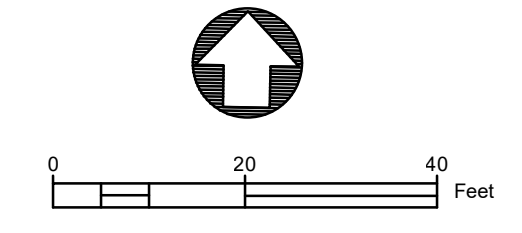

NO.	REVISIONS	DATE

12100 NE 195th St, Suite 300  
Bellevue, Washington 98011  
425.885.7877 Fax 425.885.7963

**CORE**  
DESIGN  
ENGINEERING • PLANNING • SURVEYING

**EX. CONDITIONS, DEMO, FOUNDATION  
MERCER ISLAND CC**

8700 SE 71ST STREET  
MERCER ISLAND, WA 98040

DATE	SEE STAMP DATE
DESIGNED	FLAVIO BAINOTTI
DRAWN	MATT BISHOP
APPROVED	_____
	PROJECT MANAGER


SHEET	OF
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PROJECT NUMBER	
20033	

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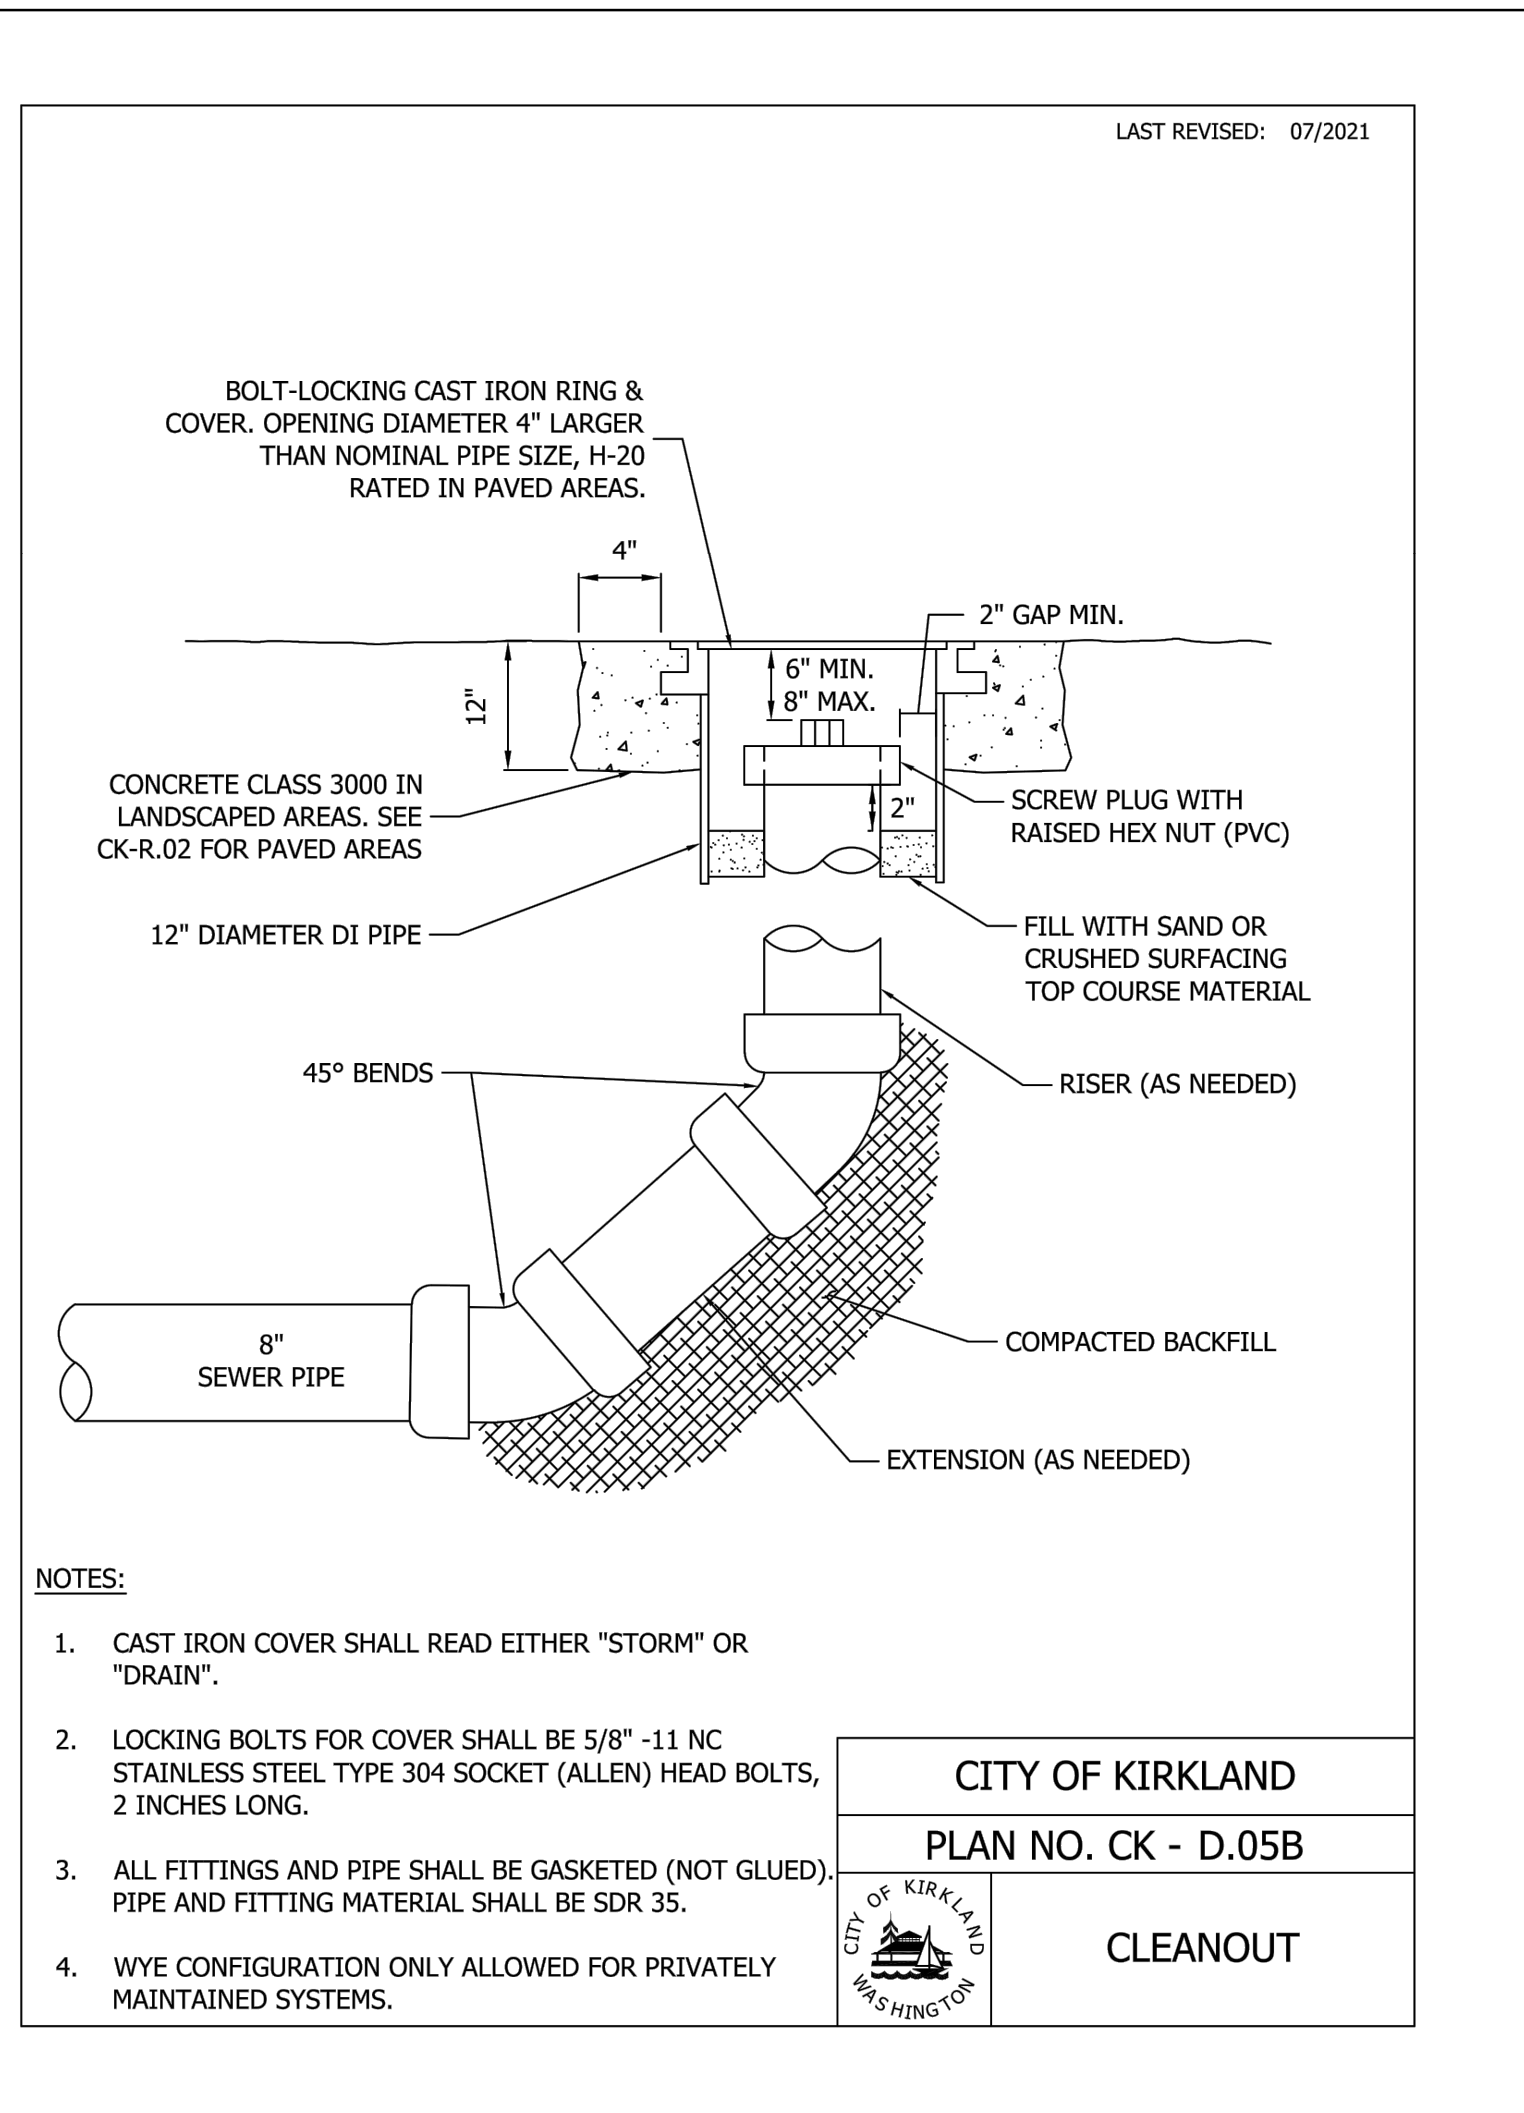






**NOTES:**

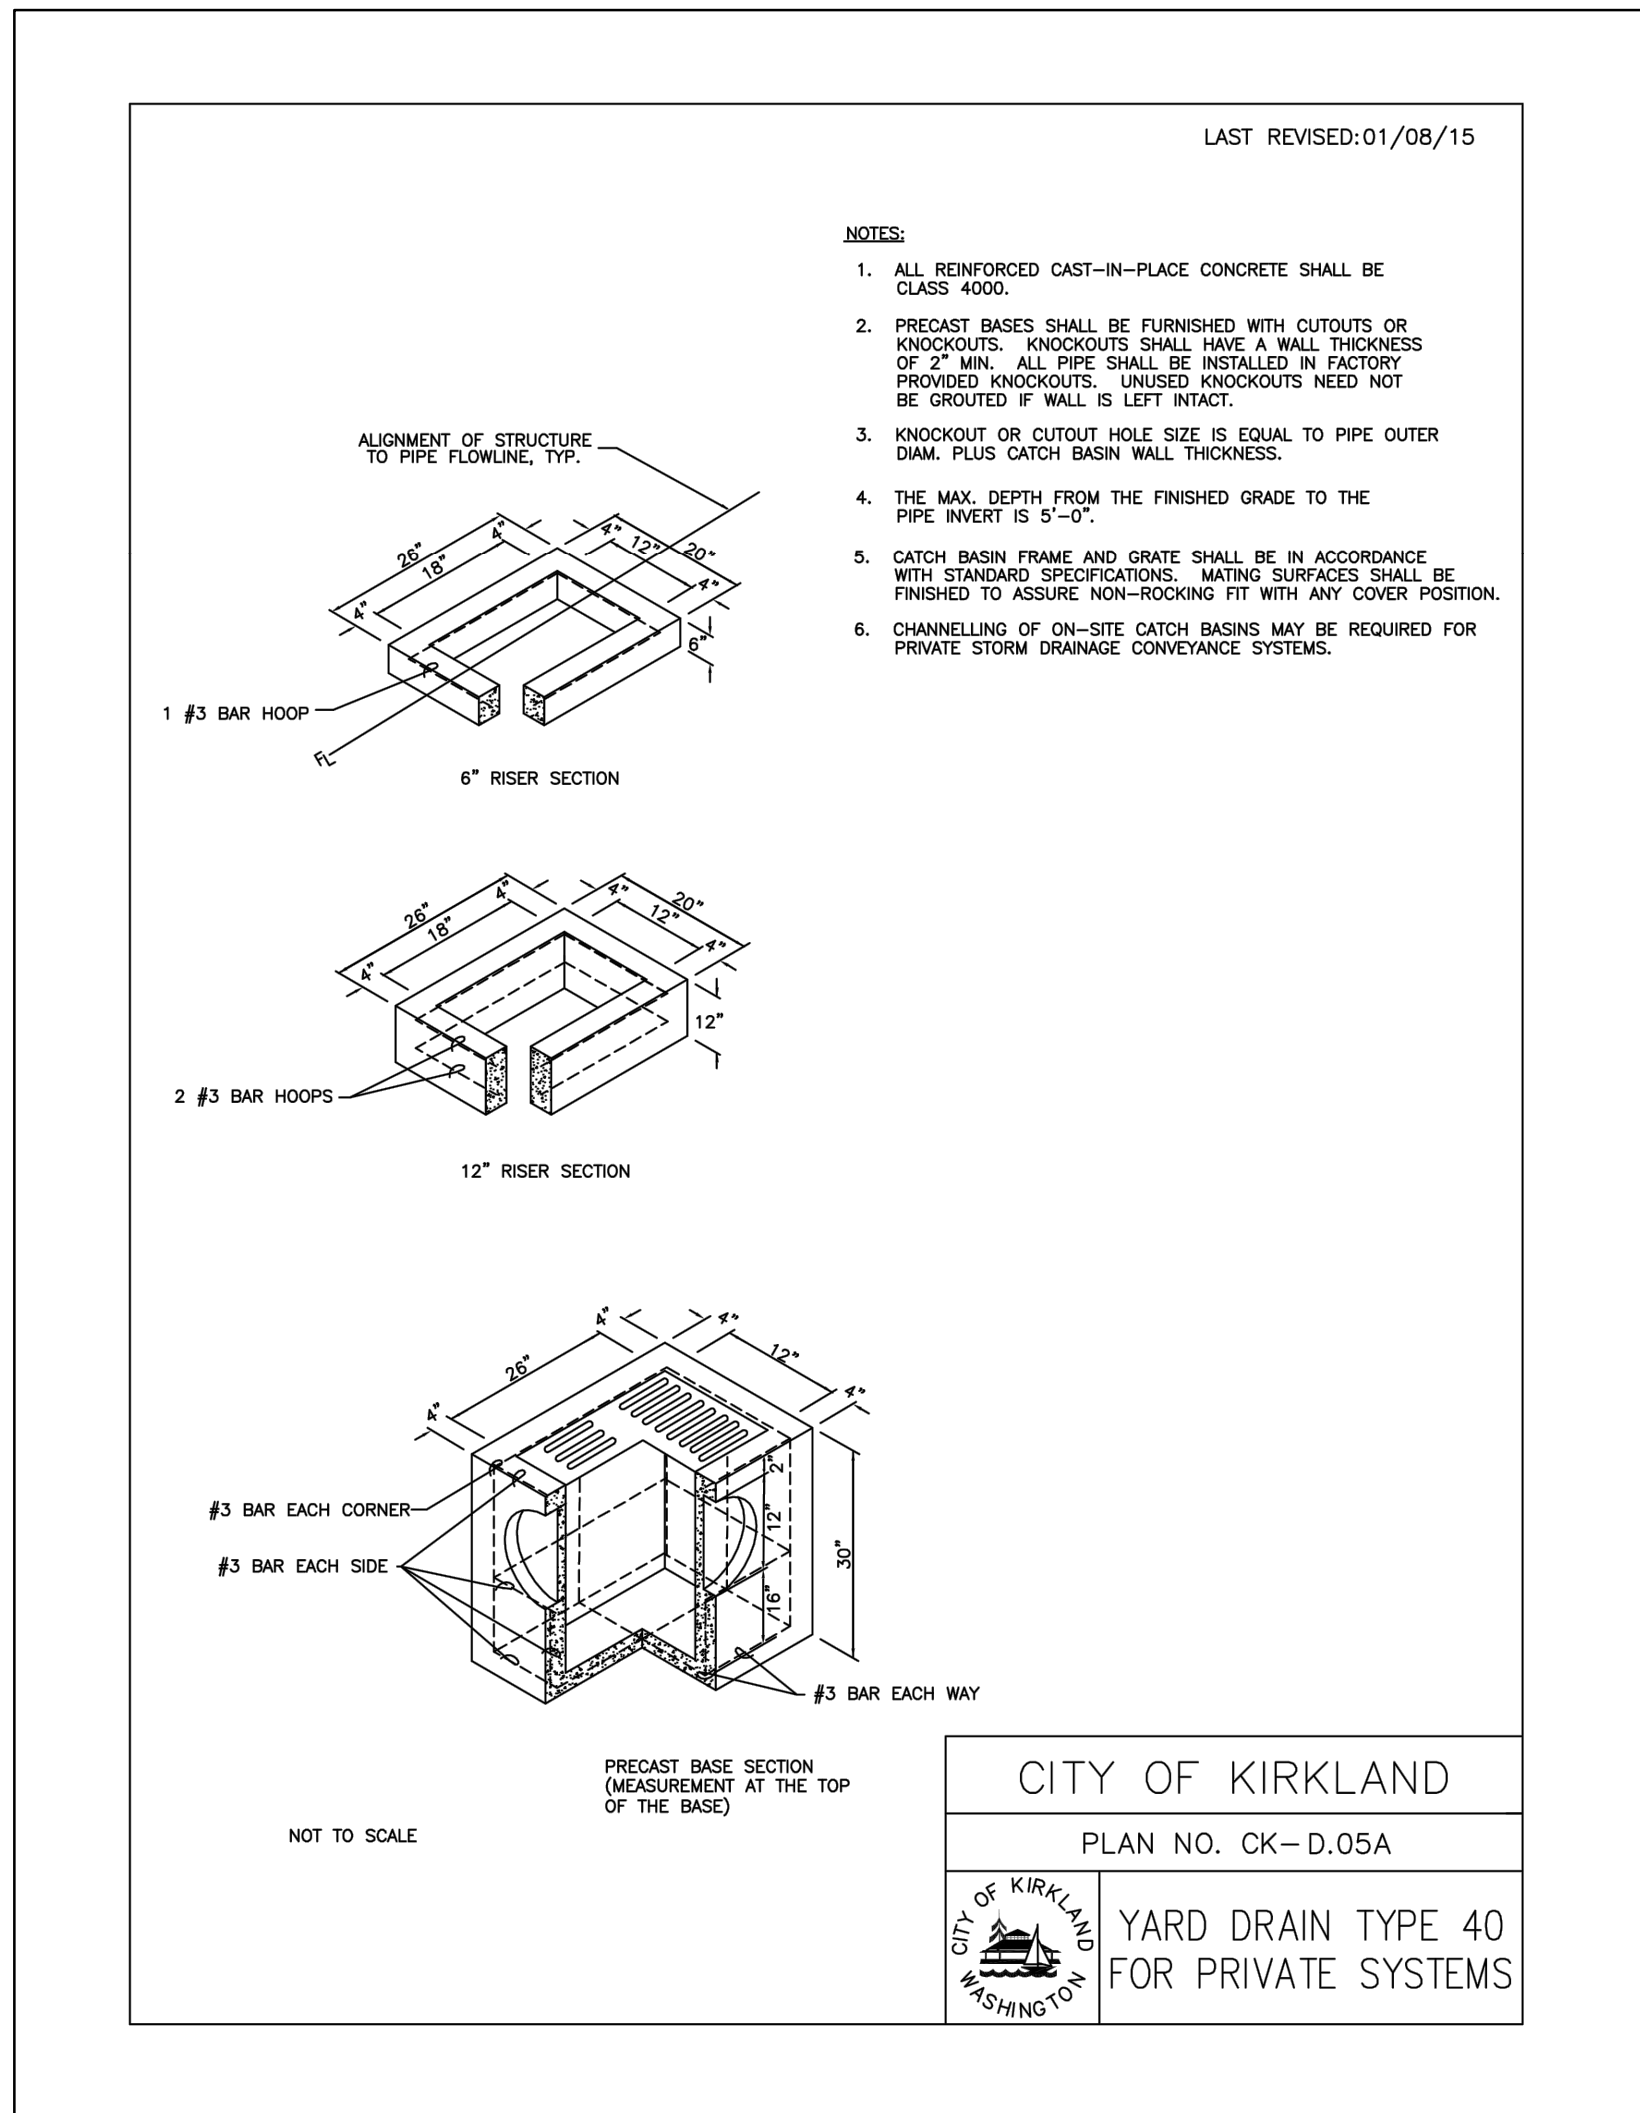1. ALL REINFORCED CAST-IN-PLACE CONCRETE SHALL BE CLASS 4000.
2. PRECAST BASES SHALL BE FURNISHED WITH CUTOUTS OR KNOCKOUTS. KNOCKOUTS SHALL HAVE A WALL THICKNESS OF 2" MIN. ALL PIPE SHALL BE INSTALLED IN FACTORY PROVIDED KNOCKOUTS. UNLESS KNOCKOUTS NEED NOT BE GROUTED IF WALL IS LEFT INTACT.
3. KNOCKOUT OR CUTOUT HOLE SIZE IS EQUAL TO PIPE OUTER DIA. PLUS CATCH BASIN WALL THICKNESS.
4. THE MAX. DEPTH FROM THE FINISHED GRADE TO THE PIPE INVERT IS 5'-0".
5. CATCH BASIN FRAME AND GRATE SHALL BE IN ACCORDANCE WITH STANDARD SPECIFICATIONS. MATING SURFACES SHALL BE FINISHED TO ASSURE NON-ROCKING FIT WITH ANY COVER POSITION.
6. CHANNELLING OF ON-SITE CATCH BASINS MAY BE REQUIRED FOR PRIVATE STORM DRAINAGE CONVEYANCE SYSTEMS.



**NOTES:**

1. CAST IRON COVER SHALL READ EITHER "STORM" OR "DRAIN".
2. LOCKING BOLTS FOR COVER SHALL BE 5/8" -11 NC STAINLESS STEEL TYPE 304 SOCKET (ALLEN) HEAD BOLTS, 2 INCHES LONG.
3. ALL FITTINGS AND PIPE SHALL BE GASKETED (NOT GLUED). PIPE AND FITTING MATERIAL SHALL BE SDR 35.
4. WYE CONFIGURATION ONLY ALLOWED FOR PRIVATELY MAINTAINED SYSTEMS.

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